



DEVELOPMENT PROJECT FILE
for
EASTLINE VILLAGE
(PL160097)


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EASTLINE VILLAGE

PL160097



**SITE
CSS**

**SITE
R-4**

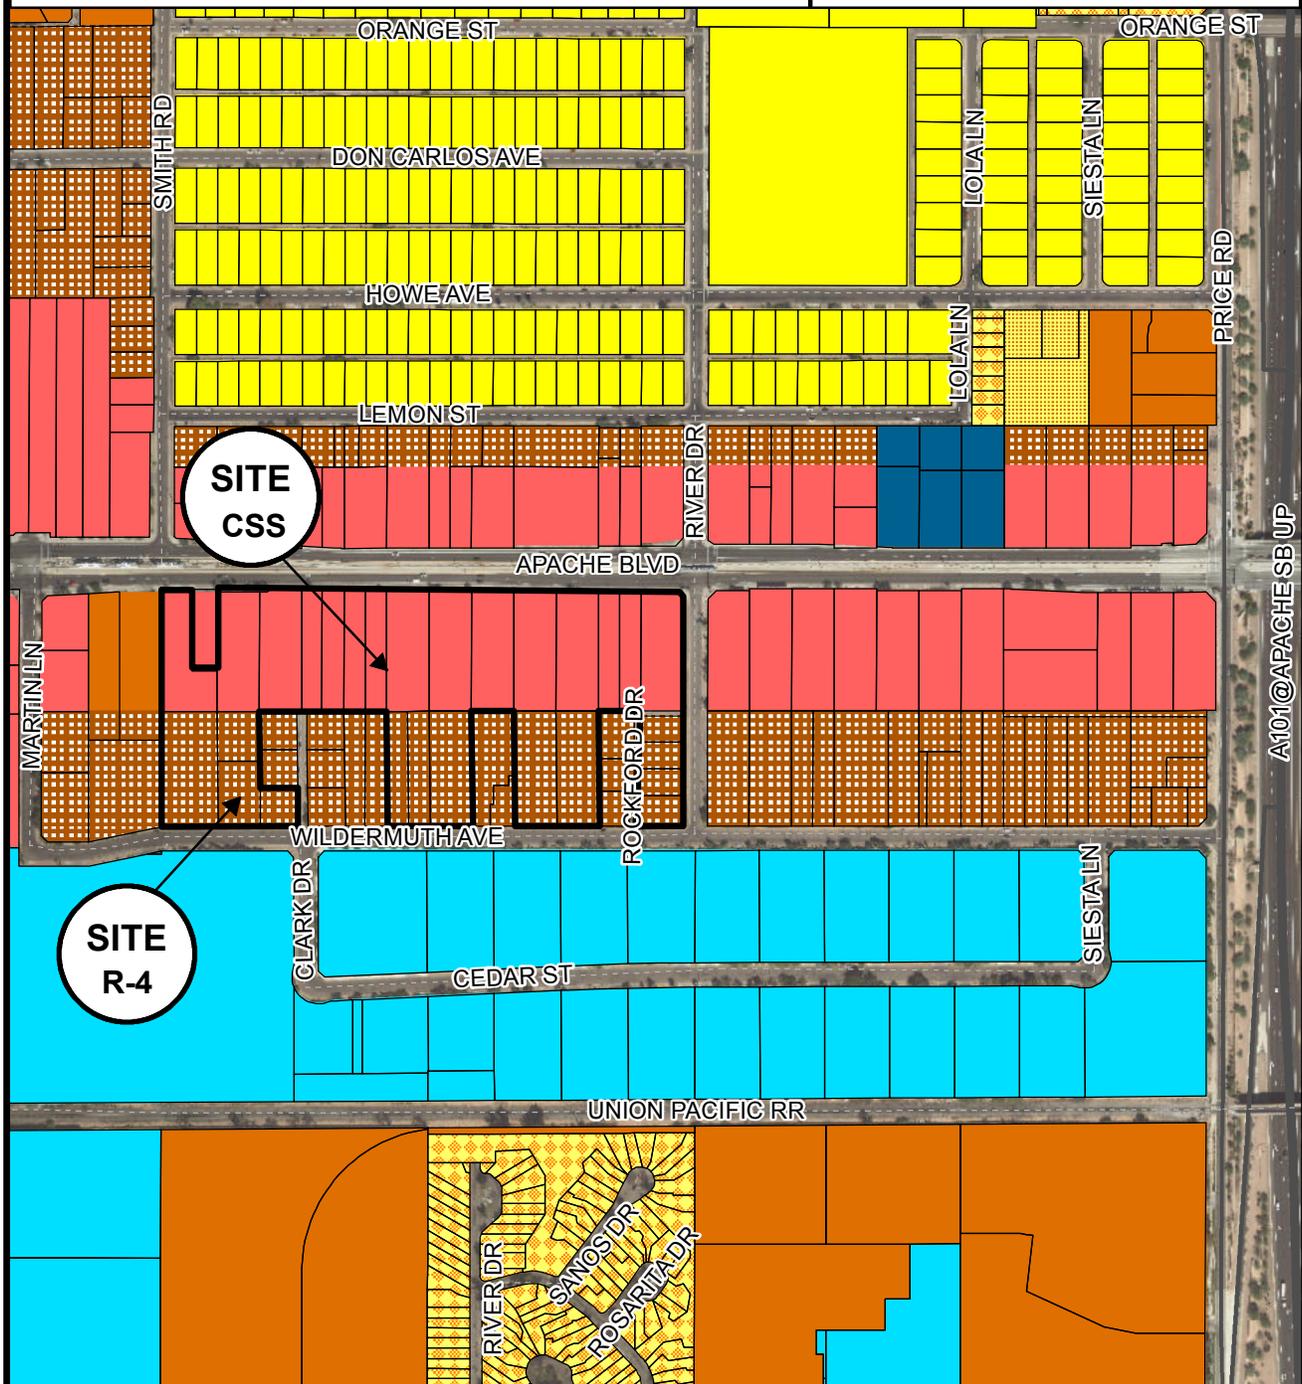
- CSS
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- R-4



Location Map

EASTLINE VILLAGE

PL160097

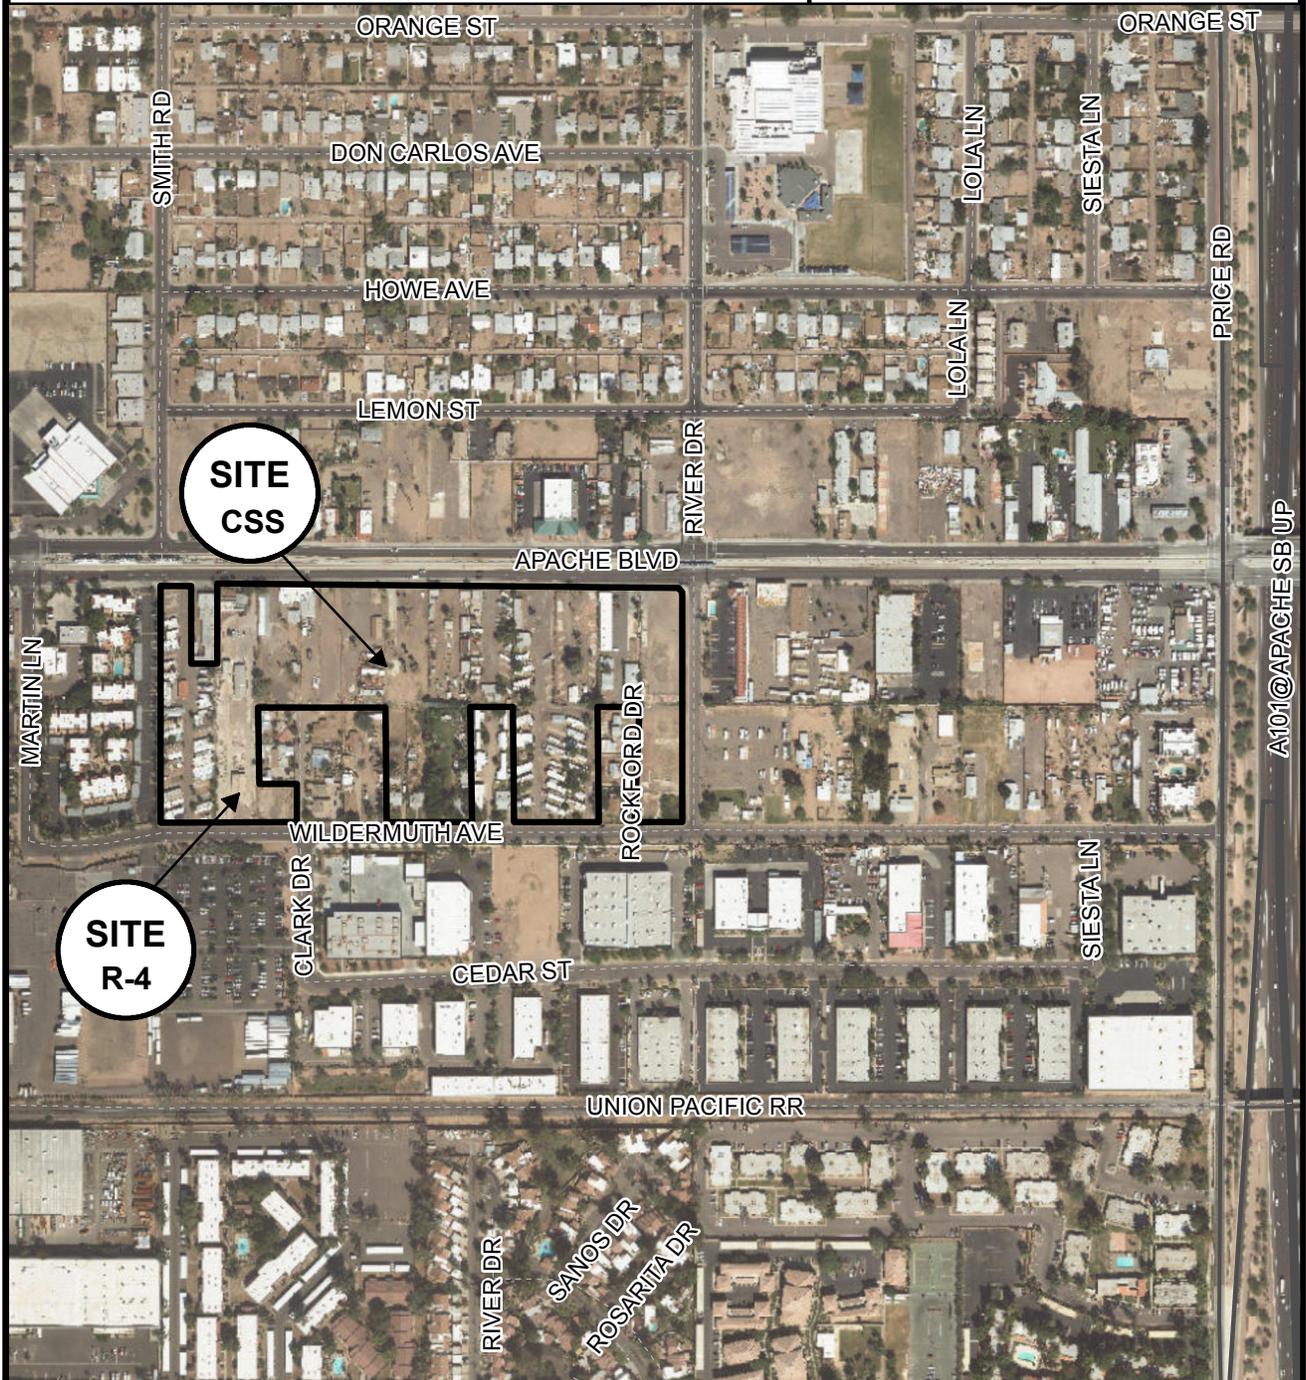

Aerial Map

EASTLINE VILLAGE

Applicant's Letter of Explanation

Zoning Map Amendment, Planned Area Dev. Overlay and Dev. Plan Review Applications

Eastline Land Ventures, L.L.C. (the "Applicant"), a partnership between DMB Associates, Inc. ("DMB") and Apache Partners and Trust No. 95000148, respectfully submits these applications to redevelop 13.56 acres generally located along Apache Boulevard between the Smith Road alignment and River Drive in Tempe, Arizona (the "Site"). The Site, which is comprised of 27 parcels, is generally located between Apache Boulevard to the north, Wildermuth Avenue to the south, Smith Road alignment to the west, and River Drive to the east. See **Exhibit A** for an aerial photograph of the Site and surrounding uses.

Applications

The Applicant is submitting the following applications: 1) a zoning map amendment, 2) a planned area development ("PAD") overlay, and 3) a development plan review ("DPR") application for the redevelopment of the Site (collectively, the "Applications"). The purpose of these Applications is to facilitate the redevelopment of the Site and to allow the development of a mixed-use urban village which will anchor that portion of Apache Boulevard that will serve as an important eastern entry point to the City of Tempe (the "City"). This village, which will be called Eastline Village, will consist of a mix of uses including multi-family residential (+/- 688 market-rate apartment units and 10 for-sale live-work condominium units) flex office/retail (+/- 38,166 square feet), restaurants (+/- 11,800 square feet), gym/yoga studio (+/-7,000 square feet) and bar (+/- 2,500 square feet) uses along with associated parking, landscape improvements, and amenities (referred to interchangeably as the "Project", "Eastline Village" or the "Village"). The Village is an urban neighborhood designed with an appropriate mix of uses and a commitment to walkability and the pedestrian experience, all with convenient accessibility to the light rail.

The purpose of the zoning map amendment request is to rezone the Site from the Commercial Shopping and Services ("CSS") and Multi-Family Residential General ("R-4") districts to Mixed-Use, High-Density ("MU-4") with a Planned Area Development ("PAD") overlay within the Transportation Overlay District's ("TOD") Station Area. The purpose of the PAD is to establish site specific development standards required to accommodate the proposed mixed-use development. The Applicant is also requesting DPR approval for the design of the Project's first phase, including site and landscape plans, building elevations and materials. A DPR for the Project's second phase will be processed at a later date as market conditions warrant the development of the future phase.

The Applicant is actively pursuing the acquisition of additional parcels contiguous to the Site. In the event that this acquisition effort is successful, the Applicant will submit a zoning map amendment request and PAD and DPR applications to incorporate these parcels into the Project by adding buildings, replacing surface parking with structured parking, and by providing additional amenity space.

Eastline Village represents a rare opportunity to redevelop multiple small parcels which have been assembled over more than a decade to create a unique project that will make a substantial statement along the Apache Boulevard light rail corridor. This redevelopment is representative of the ongoing attention and investment occurring along the light rail corridor and throughout greater Tempe

that has been planned for and envisioned for years by policy makers. The intent of the Applications is to further improve and diversify the mix of uses along the light rail corridor by building an urban mixed-use village that will become a vibrant neighborhood.

The Applicant's vision is to create a community with a strong sense of place that lives like a close knit neighborhood village rather than a series of unrelated apartment buildings that are placed next to each other. Instead of multiple developers building unrelated projects on individual lots which will inevitably become separate residential communities with no connection, the Eastline Village will be a highly sought after dynamic neighborhood for urban dwellers.

Consistent with the City's vision for the Apache Character Area, our intent is to assemble enough parcels to support a meaningful development and to develop them into a clearly defined neighborhood. The goal is to create a model for mixed-use urban redevelopment that integrates innovation, creativity, recreation, culture community building, and sustainability.

DMB Background and Development Philosophy

Founded in 1984, DMB has developed a national reputation for creating communities and projects that respect the land and enrich the way people live and work. DMB has created some of the country's finest master planned communities, many of which are grand in scale and are on dramatic topographic sites. DMB master planned communities in the Valley include DC Ranch, Eastmark in Mesa and Verrado in Buckeye. While these well-known projects represent large scale master planned communities, DMB has also developed urban, mixed-use projects, most notably, Centerpoint on Mill. This project in downtown Tempe was a unique partnership between DMB and the City which resulted in the redevelopment of the twenty-two (22) acre site that has been an important property on Mill Avenue.

While all DMB properties are different, the approach to plan, develop and cultivate community in each development is the same. The goal of DMB is to create legacy communities that live well over time. Care and attention to the context of each community is important as each community must relate well to its setting. Within this context, the creation of a vision and land plan that will form the framework for the community is developed. Land planning, streets and public spaces, architecture and neighborhood crafting are all carefully considered and utilized to create a sense of place. While the built environment forms the physical home, what is really most significant is how people relate in the space and how the community coalesces. The built spaces are important because they are the backdrop for important moments and events of life, places of safety and creation of memories. It is the combination of these factors that define the method in which DMB approaches the development of its communities and which will be implemented in the development of Eastline Village.

Within Eastline Village, DMB plans to incorporate a grid of neighborhood streets with on and off-street parking connecting neighborhood buildings versus the typical apartment complex defined by a sea of parking, perimeter walls and limited access. While parking lots and privacy walls are cheaper to build, connected tree lined urban streets for walking provide a setting for chance encounters and expressions of civic stewardship and pride. Similarly, rather than providing typical "throw away" commercial space, the Village, because of the significant assemblage of land, can incorporate an active neighborhood main street and plaza perpendicular to Apache which can anchor the neighborhood, be closed for weekend festivities, and host seasonal events.

Market Demand

In recent years, the City and other communities have experienced an influx of multifamily projects. The primary driving forces behind this increase in new multi-family residential projects in Tempe are pent-up demand, vacancy rates and a shift in residential market demand brought on by changing consumer preferences for housing types. As a result of more numerous and less flexible lending regulations, the prospect of home ownership remains far less attainable for first time and repeat home buyers. At the same time, multi-family residential properties offer a lifestyle of independence and freedom from the responsibilities of home ownership. These properties also provide residents with an opportunity to reside in urban locations which are closer to work, entertainment and recreation opportunities, and alternative modes of transportation, such as light rail service. High-quality apartments, especially those of a quality that may be converted into ownership units as the market warrants, are an appealing housing option for both families and/or individuals that provide an opportunity to experience new neighborhoods and lifestyles in an attractive setting without the financial commitment of home ownership. See **Exhibit D** for a list of enhanced building standards and design features that will help to distinguish the Village from other developments along the Apache corridor.

Site Area

The Site is comprised of 27 parcels totaling approximately 13.56 acres in size. The Site is located along the south side of the Valley Metro Apache Boulevard light rail line generally between the Smith Road alignment to the west and River Drive to the east. A full legal description is included in the submittal packet for the Applications.

Area Context

The Site is comprised of unimproved or underutilized properties. As reflected by the aerial photograph provided in **Exhibit A**, the area surrounding the Site is developed with a mix of employment, public, commercial, and residential uses, as well as multiple underutilized, vacated or unimproved properties. Specific uses in proximity to the Site include:

- The Valley Metro light rail line within the median of Apache Boulevard;
- The Apache Boulevard / Smith-Martin light rail station platform within the median of Apache near the northwest corner of the Site;
- The two story La Paloma apartments adjoining the Site to the west;
- The Roadway Inn motel to the east across River Drive;
- A U.S Post Office at the northwest corner of Apache Boulevard and Smith Road ;
- American Five Star Transmission and a palm reading establishment along the north side of Apache Boulevard; and,
- A UPS customer center, City of Tempe Fire Department support services center, U.S. Industrial Fastener of Arizona, All Wood Treasures furniture, and Alliance Fire Protection along the south side of Wildermuth Ave.

The Applicant envisions that the development of Eastline Village will continue to revitalize the Apache Boulevard corridor and significantly enhance the area's urban environment by providing high-quality and modern residential, employment, shopping, dining, entertainment and amenity opportunities within walking distance of the Apache Boulevard / Smith-Martin light rail station.

Planning Context

General Plan 2040

The Applicant is proposing a high-quality mixed-use development comprised of high-density multi-family residential, office/retail and restaurant uses. The Project's incorporation of commercial, leasing office and amenity (i.e. gym) spaces along the Apache Boulevard street frontage combined with the creation of a neighborhood main street and plaza with active use spaces will bring much needed energy to this portion of Apache. The uses and design of the Village are consistent with the Apache Boulevard Character Area Plan and will forward the aspirations of this Plan.

As shown by the maps provided in **Exhibit B**, the land use projected for the Site by General Plan 2040 is Mixed-Use. The residential density projected for the Site by General Plan 2040 is High Density (up to 65 units per acre). According to the General Plan, the Mixed-Use category is designed to accommodate a mixture of residential and commercial uses. This category also encourages creatively designed developments that provide a living environment which reflect a "village" concept where there is opportunity to live, work and play within one development or area.

Eastline Village will provide opportunities to live, work, and play in one location. Specifically, the development of the Project will provide new multi-family residential, for-sale live-work condominium, office/retail and restaurant opportunities along the Apache Boulevard light rail corridor, as well as on-site amenities for future residents of the Village and residents in neighborhoods surrounding the Site. The Project, which will result in an overall residential density of approximately 51.82 units per net acre, is the exact type of mixed-use, high-density project envisioned by General Plan 2040 for the Site.

Apache Character Area Plan

In order to further the goals and implement General Plan 2040, the City of Tempe recently adopted the Apache Character Area Plan (the "Character Plan"). The Site is located within the Character Plan's specified boundaries. The intent of the Character Plan is to provide a policy framework which guides the redevelopment vision and design for the Apache area while preserving core neighborhoods at the same time. The Project has been designed within the context of the Character Plan's place-making principles and design guidelines. Specifically, the Character Area principles listed below are those which are most closely aligned with the vision for the Village.

- Mobility: Tempe's vision as a 20-minute city;
- Streetscapes: Streets as Open Space;
- Shade (Natural & Structural);
- Landscape Treatments – The Sonoran Desert has a unique landscape which serves as a community differentiator, rich with rare textures and forms;
- Pocket Parks + Parklets – Enhance sense of place by reclaiming and providing spaces for people;
- Pedestrian Scale: Foster Apache as a premier pedestrian environment and destination;
- Walkable Commercial / Foster Active Living; and,
- Green Infrastructure – Utilize the efficiency of natural systems where possible.

Rail Corridor Growth Area & Apache Boulevard Redevelopment Area

The Site is also located within the Rail Corridor Growth Area (“RCGA”) and the Apache Boulevard Redevelopment Area (“ABRA”) designated by General Plan 2040. Along the Apache Boulevard alignment of the rail corridor, General Plan 2040 calls for the continued infusion of high-density, mixed-use and transit oriented development. The general purpose of the ABRA is to encourage reinvestment in order to build a more desirable neighborhood in which people enjoy living and working within, as well as to upgrade existing development by introducing viable long-term businesses and mixed-use projects.

The Village represents a substantial reinvestment in the RCGA and represents an opportunity to improve unimproved and underutilized properties with a viable mixed-use and transit oriented development. The Village will provide high-quality housing, employment, dining, shopping and entertainment opportunities that will further foster an enjoyable living, working and playing environment within both the RCGA and ABRA.

Current Zoning

The parcels adjacent to Apache Boulevard are currently zoned Commercial Shopping and Service (“CSS”). The parcels on the southern portion of the Site adjacent to East Wildermuth Avenue on their southern border are zoned Residential-4. A zoning map illustrating the respective locations of current zoning classifications for the Site and area is enclosed as part of the submittal packet for the Applications (see **Exhibit C**).

Within the TOD *Station Area*, the CSS district, subject to use permit approval, allows a maximum residential density of 25 units per acre and a maximum building height of 35 feet (45 feet when residential units are within a building located above commercial use(s)) and the R-4 district permits 40 units per acre and a maximum building height of 60 feet. Within the TOD’s *Corridor Area*, the CSS district, subject to use permit approval, allows a density of 20 units per acre and the R-4 district allows a maximum residential density of 25 units per acre and a maximum building height of just 40 feet. The residential density and building height allowed within the CSS and R-4 districts are inconsistent with the residential density projected for the Site by General Plan 2040. The CSS and R-4 districts’ allowable height and density are also inconsistent with the general purpose of both the RCGA and ABRA, as the CSS and R-4 suburban development standards are not conducive to the development of high-quality, mixed-use and transit oriented development which will provide needed viable long-term housing, employment, shopping, dining, and entertainment opportunities.

The purpose of the Applications is to rezone the Site from CSS and R-4 to MU-4 within the TOD Station Area to accommodate the development of a urban village that will include a vibrant mix of uses that will further promote the “village concept” of living, working and playing in one location and which will be more in keeping with the recommendations of the General Plan 2040. As in many urban places, the Applicant envisions that most of the social activity and interaction will occur on the streets/plazas and the connectivity of the urban elements via an active street scene will be the key to this framework. The intent is to provide a social living room to enhance and encourage community interaction. In order to establish the site specific development standards for Eastline Village, the Applicant is requesting a PAD overlay.

Project Description

With the completion of the light rail, it is inevitable that reinvestment will occur along the corridor and especially in areas proximate to the light rail stations. This type of investment has occurred along transit facilities throughout the United States and this revitalization was anticipated and hoped for in the City of Tempe. With the widespread use of the Valley Metro light rail, redevelopment and the creation of fun, urban living environments long anticipated by policy makers is occurring. The rejuvenation of areas along the light rail, including the development of higher intensity residential uses in conjunction with complementary commercial is bringing energy and vibrancy back to many blighted areas. This type of development is also creating a renaissance for the surrounding areas. This reinvestment and re-engagement was anticipated and is encouraged in the General Plan 2040.

The development of Eastline Village is the culmination of decades of thoughtful planning and investment on the part of the City of Tempe as described above and the Project presents an extraordinary opportunity to develop a unique mixed-use urban village and transform the Apache Boulevard light rail corridor with a unique mix of residential, employment, shopping, dining and entertainment uses that will complement the corridor's existing mix of uses and serve as a catalyst for future development along the City's eastern gateway.

The purpose of the Applications is to redevelop unimproved and underutilized properties located along the Apache Boulevard light rail corridor and to further energize the RCGA and ABRA growth areas by providing high-quality, modern housing opportunities along with supporting employment, shopping, dining and entertainment uses. Eastline Village is envisioned as a truly unique living environment for those seeking a more sustainable way to reside, work and play in Arizona's most urban, creative, education-focused and forward-thinking city. As noted previously, DMB partnered with the City to plan and develop a 22 acre mixed-use development that was the foundation for the redevelopment of downtown Tempe. With this project on Apache, the Applicants want to partner with the City once again to start the revitalization of the east end of Apache Boulevard and create a neighborhood showcasing urban redevelopment that integrates innovation, creativity, recreation, culture, community building and sustainability. Eastline Village can set the standard for an urban mixed-use master-planned community.

The Site's location along the Apache Boulevard light rail line provides a unique opportunity to further encourage the rejuvenation of the Apache development corridor, to enhance pedestrian activity along Apache, and to add to the residential and commercial use mix along Apache envisioned by General Plan 2040. In order to provide the desired active and urban presence, as well as to enhance pedestrian activity along Apache Boulevard, the Project's office/retail, restaurant, leasing office, gym, bar and bike barn spaces are located along and oriented towards the Apache Boulevard frontage as well as the Project's neighborhood main street extending into the center of the Site from Apache Boulevard.

Specifically, the Applicant is proposing a walkable, modern neighborhood consisting of high quality multi-family residential, office, retail and restaurant/bar space uses, of which approximately 954,015 square feet is residential space, 38,166 square feet is office/retail space, 11,800 square feet is restaurant space, 7,000 square feet is gym/yoga studio space, and 2,500 square feet is bar space. The overall Project includes:

- Buildings ranging in height from one to six stories with ground level commercial, amenity, live-work and leasing office use spaces along Apache Boulevard and/or the Project's neighborhood main street;
- A total of 688 apartment units containing a total of 992 bedrooms;
- A total of 10 for-sale live-work condominium units containing a total of 10 bedrooms;
- A neighborhood main street and plaza lined with active uses extending into the center of the Site from Apache Boulevard;
- Community pools and amenity decks centrally located within mixed-use buildings distributed throughout the development; and,
- 1,385 vehicle parking spaces provided within garages and parking courtyards, as well as on and off-street parking, distributed throughout the Site

The Project's mixed-use buildings will provide a combined total of 688 high-quality, modern apartment units on the Site. The market-rate apartments will include a mix of one, two and three bedroom units. The Project will also provide 10 one-bedroom for-sale live-work condominium units along the Site's Apache Boulevard frontage. The Project will include top-tier amenities, including but not limited to community pools, amenity courtyards, a gym and private balconies. In addition, two of the buildings will be clustered around a neighborhood main street and pedestrian plaza with active uses intended to create an active urban activity hub for residents of both the Village and the surrounding area.

Eastline Village is designed on a lot and block model. The lot and block model includes neighborhood blocks that are completely open to the community, rather than behind gated entries. This block by block concept allows the neighborhood expansion to be integrated in phases and allows for phased development of the Village. All of the residential units will have high-quality, interior finishes throughout. Specific features within each of the Village's residential units will include but are not limited to nine-foot clear ceiling heights, an attached direct access full-bathroom for each bedroom, a full-sized washer/dryer within a separate laundry room with extra storage, walk-in closets in each bedroom, an open floorplan concept for kitchen, dining and living rooms, an eight by three-foot built-in kitchen island and separate pantry area, and oversized recessed balconies (see **Exhibit D** for a comprehensive list of enhanced building standards and design features to be used and/or provided at the Village). While the lot and block neighborhoods are the most expensive to build, this type of time-tested investment has proven very successful over a long period of time and will allow conversion into condominiums as market conditions warrant.

Project Design

The design of Eastline Village is an attractive, modern and pedestrian friendly design that both thoughtfully engages and respects the surrounding community. As reflected by the enclosed conceptual elevations for the two buildings to be constructed within the Village's first phase of development, the overall architectural character is a contemporary design allowing for a timeless and modern look. While the design will reflect the modern aesthetic of other recently constructed buildings along the Apache Boulevard light rail corridor, it will also fit in with and respect the local neighborhood.

The Village's overall design is based on the traditional city block grid system that has proven very successful across the country in creating walkable, sustainable urban neighborhoods that foster people interaction. The driveway entrances into the site are designed to mimic local streets, extending into and through the Village with angled and parallel parking, street trees and paved sidewalks. The

design provides elements that cater to the pedestrian through the use of building character, signage, connectivity, landscaping, hardscape, and lighting.

The two main buildings included in the first phase of the development include seven-story residential buildings, built on top of a parking garage and ground floor commercial space. Parking for residential units is provided within each building, secured, and completely screened from street view. Parking for visitors and commercial uses is conveniently located along the Village's main drives and within parking courtyards on the south side of the Site. Electrical service entrance and meter sections, as well as trash and recycle containers and compactors, are placed inside the buildings and fully screened from the exterior view.

Each of the first phase's main buildings contain approximately 220 apartment units with a variety of one, two and three bedroom units ranging in size from 917 to 1,960 square feet, which is much larger than unit sizes associate with a typical apartment development. Each first phase building also includes five live-work condominium units providing 511 to 734 square feet of ground-level office/retail space along the Site's Apache Boulevard frontage with 658 to 735 square feet of office space on the second level. Each of these buildings will feature secure garage access, convenient elevator access to each floor, and interior air-conditioned lobbies and corridors. An approximate 11,000 square-foot resort style deck park built above the parking garage and wrapped by residential units will also be provided within each of these buildings. The decks will be heavily landscaped and will include a large swimming pool and spa, several BBQ areas, a large Gazebo and variety of seating, lounging and active gaming areas that will create inviting, comfortable outdoor gathering places for residents. Each apartment unit will also have a large 'private open space' in the form of a balcony or patio. This unique design with a large amenity deck in the middle provides each living unit with unobstructed views to the surrounding area, the Village's plaza and/or the building's amenity deck.

Ground floor commercial uses are placed along the Site's Apache Blvd. frontage and extend into the plaza located between the main buildings within the Village's first phase development. The plaza is designed to become a gathering place within and the center of activity for the Village. It will feature small restaurant/bar buildings with a large open space in between. A fountain/sculpture placed in the middle of the plaza will serve as a focal point. The center portion of the plaza will extend across the adjoining drives with raised decorative pavement, providing connectivity with the main entry elements of commercial spaces on either side. Both ends of the plaza will also have direct connection with adjoining commercial spaces. The one-way drives on each side of the plaza may also be closed off to create an approximate one acre gather place for special events.

The building design is inspired by the 'Bauhaus' and 'International Style', some of the most influential currents in modern architecture. This style and character of architecture is characterized by straight edges and smooth rectilinear forms in a balanced composition that expresses the form and functionality of its components. By principal the design is void of all arbitrary applied ornamentation, striving towards simplicity, honesty and clarity of form and beauty. The building style is a classic, contemporary and timeless design. While it may be a synthesis of the various trends of the modernist movements in architecture and urban planning, it is an approach to architecture that transcends 'style'. The design approach for the Village was to research users' needs and to scientifically develop a design solution that integrates traditional precedents with new social demands and effective building components. The art and real beauty of this design is the accommodation of all these aspects.

The design concept is addressed in further detail within the development plan review approval criteria section of this letter of explanation provided below.

Sustainability

While each DMB community is unique, DMB has always considered responsible development to be one of the hallmarks of its brand and philosophy, whether it's through the preservation of desert environment (DC Ranch and Verrado) or the reuse and recycling of existing materials (Eastmark). At Eastline, concepts of sustainability will be put into play in a manner that achieves the biggest impacts and which provide an overall positive return to the project sustainability. Building methods, architecture, site planning, building orientation, landscaping, drainage and other methods that contribute to the overall project sustainability will be evaluated and implemented in a methodical manner.

The Applicant anticipates achieving a high level of sustainability for the Project by utilizing recognized green building features and practices. The building and unit design will incorporate environmentally sustainable elements to increase energy efficiency, including, but not limited to high efficiency mechanical equipment and water heaters, energy rated appliances, low energy use LED light fixtures, dual glazed low-e windows and patio doors, and reduced flow toilets and plumbing fixtures. Additionally, pro-active recycling measures will be implemented on-site for the residents and commercial users. Construction activities will also be subject to extensive recycling of construction materials.

Landscape Design

The minimum landscape coverage to be provided for the first two phases of the proposed mixed-use development, including resident amenity decks and landscaped areas within and around surface parking areas which may be developed as buildings and/or parking structures as part of later phases, is approximately 25 percent, a significant amount for a development in an urban setting. In addition, approximately 26,000 square feet of landscape and hardscape improvements will be provided within the adjoining right-of-way. The intent of the landscaping design is to create garden-like environments that are segregated from vehicular traffic and create a park-like feel for residents and guests that will also serve as an integral part of the overall landscape design for the Project. The proposed landscape materials for the Village will add to the desired garden-like environment. The landscape design will include inviting open spaces for gathering and recreation, including a plaza within the neighborhood main street / plaza and swimming pools within amenity courtyards for residents' use. The selected tree species will provide ample shade for pedestrians passing by and walking through the Village. Landscaping concepts will be planned to maximize creation of shade and to soften urban edges and spaces to create a welcoming environment for people.

As reflected by the conceptual landscape plan included as part of the submittal packet for the Applications, the Project's landscape design:

- embraces non-invasive drought tolerant plant palette to promote water conservation and place-making;
- uses the Apache Character Area's historic plant palette as a resource for plant selection in appropriate areas;
- promotes biodiversity throughout the landscape to help prevent single-species die-off, disease, pest infestations, encourages sustainable plant pollination, nutrient cycling, healthy soils as well as bird and insect diversity

- supports purple-colored plants and flowering trees, shrubs and ground covers to foster community identity within the Apache Blvd. area;
- promotes a maintenance plan that does not contribute to over-grown or over-pruned arid plants, which causes shock and reduces flowering and pollination; and,
- support tall and high canopy trees which are home to birds of prey and are part of a healthy and balanced urban forestry program and habitat

Open Space & Urban Plaza Design

While great urban spaces, such as Bryant Park and Times Square, can reshape entire districts of a city, landscape voids in the urban fabric (lawns often called parks) are often found in many blighted areas. Modern apartment complexes often install greenways connecting buildings surrounded by surface parking. While these open space greenways, typically narrow bands of lawn and trees between buildings, provide unstructured recreational opportunities, most are often simply passive open spaces that provide a scenic arrival to individual homes not capable of transforming a community.

The Village, through the provision of urban social space and elements of a connective urban grid, has been designed to be transformative. The transformation of a district or area typically takes place socially. As such, open space provides the framework for such social interaction. To create such a space, one needs to make sure the size is right to contain the needed and desired vibrancy. The space needs to be able to transition from a packed holiday weekend event to a Tuesday morning stroll without ever feeling empty and abandoned, or too crowded to be welcoming. For these reasons, the Project's urban plaza has been modeled off of one of three blocks comprising the successful Santana Row regional mixed-use center in San Jose, California. The modeled block of Santana Row culminates in an urban plaza surrounded by indoor/outdoor retail and dining uses.

In addition, the Village's residential buildings have been designed to provide a semi-private recreational amenity deck above each building's parking structure. These private outdoor spaces include a pool, bar-b-que and outdoor gathering spaces, and vegetation isolated from the urban street grid. These enclosed courtyards, which have natural surveillance from surrounding units, will provide recreational amenities desired by residents and guests of modern multi-family housing.

On the south half of the Site, the development plan begins with interim surface parking lots, landscape areas and drainage basins to be developed in phases. As the Project becomes more successful and people are naturally drawn to the urban plaza at the heart of the Village, these improvements are intended to be redeveloped into urban uses which will increase the open space as part of the extended urban fabric.

Circulation and Parking

The Project, which will be accessed via Apache Boulevard, River Drive and Wildermth Ave., will provide a total of 1,385 vehicle parking spaces, of which 861 spaces will be provided within garages, 398 spaces will be provided within parking courtyards, 86 spaces will be provided off-street throughout the Site, and 16 spaces will be provided on-street along River Drive and Wildermuth Avenue. The provided parking is more than an ample amount for an urban, mixed-use development with immediate access to a light rail station. In addition, the Project will provide a total of 736 bike spaces. The number of parking spaces provided exceeds the applicable code requirement for the proposed multi-family residential, live-work, office/retail, restaurant, gym/yoga and bar uses.

A traffic impact study prepared by CivTech, Inc is included as part of the submittal packet for the Applications. The study concluded that traffic added to the adjoining roadway network as a result of the development of the Village can be mitigated to ensure that all study intersections currently providing an acceptable level of service will continue to do so.

Development Plan Review Approval Criteria

Pursuant to Zoning and Development Code 6-306, the Applicant is requesting Development Plan Review approval of architectural drawings for the Project's first phase of development, including site and landscape plans, building elevations and building materials. As discussed below, the Project is an appropriately scaled and aesthetically pleasing design that will encourage, protect and enhance the functional and attractive appearance of the Site and the surrounding area.

1. Placement, form, and articulation of buildings and structures provide variety in the streetscape

The otherwise long and tall buildings are designed with large geometric forms that break them up into smaller components to reduce the perceived scale of the buildings within the streetscape. The main lobby, stairwell and elevators are recessed into the center of the building, and provide a tall vertical element to further break up the mass and anchor the buildings to the ground. The buildings are designed to form a unified whole, connecting across the lower scale plaza in the middle. A variety of materials, textures and colors are then used to further break up the individual geometric forms within the overall composition.

2. Building design and orientation, together with landscape, combine to mitigate heat gain/retention while providing shade for energy conservation and human comfort

The longer side of each building is appropriately oriented north to south. As a result, the entire Apache Blvd. frontage will remain largely shaded at all times. The design will respect and enhance the unique climate through the use of landscaping, recessed balconies, large overhangs, articulation, material selection, textures and light paint colors. Higher density housing with multiple levels minimizes exterior wall and roof exposure to the sun. The parking garages and deck parks above minimize the asphalt area on-site, significantly reducing the typical heat-island effect.

3. Materials are of a superior quality, providing detail appropriate with their location and function while complementing the surroundings

The building design incorporates a large variety of high end materials and finishes, true to form and function. The ground/street-level includes honed, textured and integrally colored masonry walls and piers between the storefront. The main lobby is defined with thermally infused 'Novawood' and accented with fiber cement panels above. The main buildings above feature integrally colored Stucco/EFIS system, providing a fine textured/smooth surface appropriate to the modern design. Vertical standing seam and corrugated metal panels are used in selective areas to highlight important building elements, provide interest and added texture to the overall composition.

4. Large building masses are sufficiently articulated so as to relieve monotony and create a sense of movement, resulting in a well-defined base and top, featuring an enhanced pedestrian experience at and near street level

The buildings are designed with large geometric forms that break them up into smaller components to reduce the perceived scale of the buildings within the streetscape. To highlight important building volumes and features, the main lobby, stairwell and elevators are recessed into the center of the building, providing a tall vertical element that breaks up the mass, and anchors the buildings to the ground.

The ground floor commercial spaces clearly define a base for the buildings above. Deep cantilevered roof overhangs define the top. The recessed and protruding balconies break up the mass in-between and create a rhythmic movement across the building elevations that are further enhanced by accent colors at the back wall and underside of balconies, as well as the change in materials between the different elements.

5. Buildings, structures, and landscape elements are appropriately scaled, relative to the site and surroundings

As discussed in detail in the area context section provided above, the Site is located within an urban, mixed-use environment along the Valley Metro light rail line that includes a mix of employment, public, commercial, and residential uses, as well as multiple underutilized, vacated or unimproved properties. The Project's buildings and landscape elements have been designed with the context of the area in mind. In the context of the mixed-use and high-density residential development projected for the Site and surrounding area by the General Plan, recently constructed and approved mixed-use and high-density developments along the Apache light-rail corridor, and the existing employment and commercial uses in proximity to the Site, the Project's proposed six-story building height is of an appropriate scale for the area.

A minimum of approximately 25 percent landscape coverage within the Site is more than appropriate for an urban, mixed-use environment. The proposed landscape palette along Apache and the Project's neighborhood main street, as well as the landscape palette proposed for the overall Site, will also further establish and contribute to a pedestrian friendly environment along the Apache light rail corridor.

6. Building facades provide architectural detail and interest overall with visibility at street level (in particular, special treatment of windows, entries and walkways with particular attention to proportionality, scale, materials, rhythm, etc.) while responding to varying climatic and contextual conditions

The ground floor commercial space along the Apache Blvd. is designed for high visibility of tenant spaces with continuous tall storefront windows broken up by exposed masonry piers. The masonry piers are accented with lighting and tall pots with flowering plants. The piers extend into the hardscape with exposed aggregate concrete bands terminating with a shade tree along the street frontage. Most of the existing street lights will be relocated and centered between the trees, creating a rhythm of patterns

along the street. Seating areas and designated areas for bike racks are conveniently spaced out along the frontage. Series of long linear low concrete planters provide for additional planting at the main building entry area. The storefront at the corners is recessed into the building to better define entrances to major tenants and provide opportunities for future patios.

The storefront windows continue along the plaza drive frontage – broken up by wood clad concrete columns and defined major tenant elements at the center plaza crossing. The corners of the buildings fronting the plaza are extended out even further to create the opportunity for sizable covered restaurant patios. The plaza drives are lined with trees on both sides providing additional shade and interest to the pedestrian environment.

7. Plans take into account pleasant and convenient access to multi-modal transportation options and support the potential for transit patronage;

The goal of the Applications is to create a mixed-use development that will add to the mix of market rate apartments, for-sale live-work, office/retail and restaurant/bar uses along the Valley Metro light rail line, as well as enhance pedestrian street activity along the Apache Blvd. light rail corridor.

As noted above, the Site is located directly adjacent to the platform of the Apache / Smith-Martin light rail station. Considering the Site's location along the Apache light rail corridor and the proximity of the light rail station, this segment of Apache Boulevard will continue to see significant increases in pedestrian traffic for the foreseeable future. To enhance the pedestrian environment and multi-modal transportation usage, the Project will energize the ground level of the Site by providing a frontage along both Apache Boulevard and the Project's neighborhood main street comprised of street-level office/retail, restaurant/bar, leasing office, gym and bike barn uses/spaces combined with residential units above all oriented toward either an oversized walkway along the Apache street frontage or the Project's neighborhood main street.

To further encourage the use of the multi-modal transportation options available along the Apache corridor, the Project will also provide 736 bike spaces for residents, guests and patrons use.

8. Vehicular circulation is designed to minimize conflicts with pedestrian access and circulation, and with surrounding residential uses

The Project's vehicular circulation has been designed to minimize conflicts with pedestrian access and circulation. The movement of pedestrians is a major element of the Project. The Project includes a main street plaza extending into the center of the Site from Apache Boulevard. The plaza, which will be of an appropriate scale and include hard and softscape improvements, will encourage and facilitate safe pedestrian movements while calming vehicular traffic at the same time. As reflected by the site and landscape plans, the Project's design segregates pedestrian and vehicular movements to the extent possible. The Project will also provide an oversized walkway

separated and distinguished from vehicle maneuvering areas along the Site's Apache Boulevard frontage.

9. Plans appropriately integrate Crime Prevention Through Environmental Design principles such as territoriality, natural surveillance, access control, activity support, and maintenance

Crime prevention and security of residents and visitors alike is a critical factor that has been seriously considered and incorporated into the overall design. The parking garages are reserved for residents only, and secured with automatic roll down gates and electronic access controls. Visitor entry will be limited to the main lobby, a highly visible location along the street frontage. The continuous storefront and wide open sidewalks provide for natural surveillance along the building frontage. Sidewalks and parking areas will be well illuminated. The provision of a security guard will be considered as needed. Additionally, refuse and recycling compactors have been placed within the building, eliminating the hazards associated with remote service yards.

10. Landscape accents and provides delineation from parking, buildings, driveways and pathways

The proposed landscape and hardscape improvements along Apache and throughout the Site will delineate walkways, driveways, drive aisles and parking areas from the public right-of-way, as well as the Project's buildings. Appropriate trees and enhanced landscaping and hardscape materials will be placed along the Site's Apache frontage and within and/or along the Project's main street plaza and amenity courtyards to further distinguish pedestrian areas. The selected landscape and hardscape materials will also create an aesthetically pleasing and comfortable environment for pedestrians passing by or walking through the Site.

11. Signs have design, scale, proportion, location and color compatible with the design, colors, orientation and materials of the building or site on which they are located

The Project's sign package is not included as part of the Applications submittal. A comprehensive sign package will be prepared and processed for the Project at later date. The sign package will ensure that the design, scale, proportions, location and color of signage to be provided on the Site is compatible with the Project's design and uses, as well as adjoining and nearby uses.

12. Lighting is compatible with the proposed building(s) and adjoining buildings and uses, and does not create negative effects

As detailed by the photometric plan included as part of the Applications submittal, the Project's lighting will be compatible with the proposed multi-family residential and office/retail and restaurant/bar uses, as well as adjoining and nearby buildings and uses. The lighting will not adversely impact uses within the Project or adjoining and nearby uses.

Conclusion

We are very excited about the opportunity to participate in the redevelopment of the Apache Boulevard light rail corridor. Eastline Village represents the culmination of years of planning and investment by the City to focus on the quality of livability of Tempe. Eastline is an opportunity for a master plan mixed-use urban village which will be a truly unique living environment and destination for workforce, entrepreneurs, millennials and those seeking a more urban and sustainable way to live in Tempe. Eastline Village will provide sought-after housing opportunities in proximity to employment, shopping and dining uses to be provided on-site and the commercial, educational and entertainment uses located along the light rail line. The Project will offer superior amenities to future residents, provide a neighborhood gathering location and amenity in the form of a main street and plaza, and maintain appropriate relationships with the street environment and surrounding neighborhood and properties. We look forward to discussing the Project and requests with you in the near future and respectfully request your support.

PLANNED AREA DEVELOPMENT OVERLAY FOR EASTLINE VILLAGE

THOSE PORTIONS OF THE FINAL PLAT OF BUENA PARK PLAT 2, ACCORDING TO BOOK 33 OF MAPS, PAGE 38, RECORDS OF MARICOPA COUNTY, ARIZONA

ACKNOWLEDGEMENT

ON THIS _____ DAY OF _____, 2016 BEFORE ME, THE UNDERSIGNED, PERSONALLY APPEARED _____, OWNER, WHO ACKNOWLEDGED HIMSELF TO BE THE PERSON WHOSE NAME IS SUBSCRIBED TO THE INSTRUMENT WITHIN, AND WHO EXECUTED THE FOREGOING INSTRUMENT FOR THE PURPOSES THEREIN CONTAINED.

IN WITNESS WHEREOF, I HERETO SET MY HAND AND OFFICIAL SEAL

BY: _____ NOTARY PUBLIC MY COMMISSION EXPIRES _____

EASTLINE LAND VENTURES, LLC, A DELAWARE LIMITED LIABILITY COMPANY:
BY: DMB ASSOCIATES, INC., AN ARIZONA CORPORATION, ITS MANAGER

BY: _____ ANDREW BEAMS DATE _____

ON THIS _____ DAY OF _____, 2016 BEFORE ME, THE UNDERSIGNED, PERSONALLY APPEARED _____, OWNER, WHO ACKNOWLEDGED HIMSELF TO BE THE PERSON WHOSE NAME IS SUBSCRIBED TO THE INSTRUMENT WITHIN, AND WHO EXECUTED THE FOREGOING INSTRUMENT FOR THE PURPOSES THEREIN CONTAINED.

IN WITNESS WHEREOF, I HERETO SET MY HAND AND OFFICIAL SEAL

BY: _____ NOTARY PUBLIC MY COMMISSION EXPIRES _____

APACHE PARTNERS 4, LLC, AN ARIZONA LIMITED LIABILITY COMPANY:
BY: JAO UNIVERSAL, L.L.P., AN ARIZONA LIMITED LIABILITY LIMITED PARTNERSHIP, ITS MANAGER

BY: _____ JEFF JONES DATE _____

ON THIS _____ DAY OF _____, 2016 BEFORE ME, THE UNDERSIGNED, PERSONALLY APPEARED _____, OWNER, WHO ACKNOWLEDGED HIMSELF TO BE THE PERSON WHOSE NAME IS SUBSCRIBED TO THE INSTRUMENT WITHIN, AND WHO EXECUTED THE FOREGOING INSTRUMENT FOR THE PURPOSES THEREIN CONTAINED.

IN WITNESS WHEREOF, I HERETO SET MY HAND AND OFFICIAL SEAL

BY: _____ NOTARY PUBLIC MY COMMISSION EXPIRES _____

FIDELITY NATIONAL INSURANCE COMPANY INC., AN ARIZONA CORPORATION, AS TRUSTEE UNDER TRUST NO. 95000148 AND NOT IN ITS CORPORATE CAPACITY:

BY: _____ JOE A. GUTIERREZ JR. TRUST OFFICER DATE _____

ON THIS _____ DAY OF _____, 2016 BEFORE ME, THE UNDERSIGNED, PERSONALLY APPEARED _____, OWNER, WHO ACKNOWLEDGED HIMSELF TO BE THE PERSON WHOSE NAME IS SUBSCRIBED TO THE INSTRUMENT WITHIN, AND WHO EXECUTED THE FOREGOING INSTRUMENT FOR THE PURPOSES THEREIN CONTAINED.

IN WITNESS WHEREOF, I HERETO SET MY HAND AND OFFICIAL SEAL

BY: _____ NOTARY PUBLIC MY COMMISSION EXPIRES _____ CITY OF TEMPE, A MUNICIPAL CORPORATION:

BY: _____ REPRESENTATIVE DATE _____

DS151102

OWNER/DEVELOPER

EASTLINE LAND VENTURES, LLC
ANDREW BEAM, REPRESENTATIVE
7600 E. DOUBLE TREE RANCH RD. #300
SCOTTSDALE, AZ 85258
480-367-7000


APACHE PARTNERS 4, LLC
JEFF JONES, REPRESENTATIVE
4422 N. CIVIC CENTER PLAZA #202
SCOTTSDALE, AZ 85251
480-367-7000

OWNER

TRUST NO. 95000148
JOE A. GUTIERREZ JR., TRUST OFFICER
60 E. RIO SALADO PARKWAY, 11th FLOOR
TEMPE, AZ 85281
480-214-4523

CITY OF TEMPE _____, REPRESENTATIVE
132 E. 6TH ST. #101
TEMPE, AZ 85281
480-350-4311

SITE VICINITY MAP

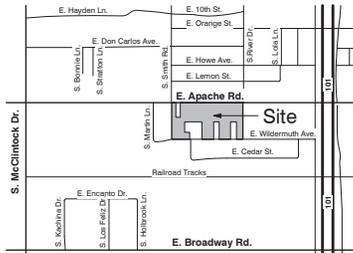

CONDITIONS OF APPROVAL:

PL160097
TBD

APPROVAL

APPROVED BY THE MAYOR AND CITY COUNCIL OF THE CITY OF TEMPE ON THIS _____ DAY OF _____, 2016.

PL160097

PROJECT DATA

ZONING DISTRICT(S) AND OVERLAY(S)	PAD Proposed
	MU-4 / TOD / PAD
GENERAL PLAN LAND USE	Mixed-Use
GENERAL PLAN DENSITY (DU/Ac)	Up to 65
SITE AREA - GROSS	590,740 SF / 13.56 Ac
SITE AREA - NET	586,566 SF / 13.47 Ac
DWELLING QUANTITY	698 DU
DENSITY (DU/Ac)	51
BUILDING HEIGHT	90 ft
BUILDING STEPBACK (Adjacent to SFR Districts)	Yes
BUILDING LOT COVERAGE	75%
SITE LANDSCAPE COVERAGE	
AT GRADE	19.6%
AT DECK PARK (2nd Floor)	5.6%
COMBINED	25.2%
BUILDING SETBACKS *	
FRONT (APACHE BLVD.)	0 ft Min / 20 ft Max
SIDE (RIVER DR.)	0 ft Min / 20 ft Max
REAR (WILDERMUTH AVE.)	0 ft Min / 20 ft Max
SIDE (INTERIOR LOT LINES)	0 ft
SIDE (WEST PROPERTY LINE)	10 ft Min
STREET SIDE - PARKING AND MANEUVERING	20 ft
VEHICLE PARKING QUANTITY REQUIRED	1207
RESIDENTIAL	
1 Bed (444 Units / 444 Beds)	333 (0.75 SP/Bed)
2 Bed (184 Units / 368 Beds)	276 (0.75 SP/Bed)
3 Bed (60 Units / 180 Beds)	135 (1.75 SP/Bed)
Live-Work 1Bed (10 Units / 10 Beds)	8 (1.75 SP/Bed)
GUEST (698 Units)	140 (0.20 SP/Unit)
TOTAL RESIDENTIAL	892
COMMERCIAL	
Bar	25 (1 SP / 50 SF) *
Restaurant	157 (1 SP / 75 SF)
Gym / Yoga	56 (1 SP / 125 SF)
Office / Retail	77 (1 SP / 300 SF) *
TOTAL COMMERCIAL	315
VEHICLE PARKING QUANTITY PROVIDED	1385
BICYCLE PARKING QUANTITY REQUIRED	717
RESIDENTIAL	
1 Bed (444 Units)	333 (0.75 SP/Unit)
2 Bed (184 Units)	138 (0.75 SP/Unit)
3 Bed (60 Units)	60 (1.00 SP/Unit)
Live-Work 1Bed (10 Units)	8 (0.75 SP/Unit)
GUEST (698 Units)	140 (0.20 SP/Unit)
TOTAL RESIDENTIAL	679
COMMERCIAL	
Bar	5 (1 SP / 500 SF)
Restaurant	24 (1 SP / 500 SF)
Gym / Yoga	4 (1 SP / 2,000 SF)
Office / Retail	5 (1 SP / 7,500 SF)
TOTAL COMMERCIAL	38
BICYCLE PARKING QUANTITY PROVIDED	736
USES	1,333,878 SF
Residential	954,015 SF
Parking Garages	289,655 SF
Storage & Utility	30,742 SF
Commercial	
Bar	7,500 SF
Restaurant	11,800 SF
Gym / Yoga	7,000 SF
Office / Retail	38,166 SF
Total Commercial	59,466

* This PAD defines the front property line as Apache Blvd., not River Dr.
 ** Parking waived for 50% of floor area, not to exceed 2,500 SF of floor area
 *** Parking waived for 50% of floor area, not to exceed 30,000 SF of floor area

REC16057

REC16057

PL160097

DS151102

K & L HOMES, LLC
4422 N. CIVIC CENTER PLAZA
SCOTTSDALE, AZ 85251
PH: 480-970-9800



Revisions		
#	Description	Date



SHEET TITLE:
PAD - Cover Sheet

SHEET NUMBER:

PAD 1

PAD / DPR #4

PLANNED AREA DEVELOPMENT OVERLAY FOR EASTLINE VILLAGE

THOSE PORTIONS OF THE FINAL PLAT OF BUENA PARK PLAT 2, ACCORDING TO BOOK 33 OF MAPS, PAGE 38, RECORDS OF MARICOPA COUNTY, ARIZONA, BEING LOCATED IN THE SOUTHEAST QUARTER OF SECTION 24, TOWNSHIP 1 NORTH, RANGE 4 EAST OF THE GILA AND SALT RIVER BASE AND MERIDIAN, MARICOPA COUNTY, ARIZONA, MORE PARTICULARLY DESCRIBED AS FOLLOWS:

LEGAL DESCRIPTION

THOSE PORTIONS OF THE FINAL PLAT OF BUENA PARK PLAT 2, ACCORDING TO BOOK 33 OF MAPS, PAGE 38, RECORDS OF MARICOPA COUNTY, ARIZONA, BEING LOCATED IN THE SOUTHEAST QUARTER OF SECTION 24, TOWNSHIP 1 NORTH, RANGE 4 EAST OF THE GILA AND SALT RIVER BASE AND MERIDIAN, MARICOPA COUNTY, ARIZONA, MORE PARTICULARLY DESCRIBED AS FOLLOWS:

BEGINNING AT THE SOUTHWEST CORNER OF TRACT D OF SAID FINAL PLAT;

THENCE NORTH 00°08'09" EAST, ALONG THE WEST LINE OF SAID FINAL PLAT, FOR A DISTANCE OF 575.28 FEET TO A POINT 57.00 FEET SOUTH OF THE NORTH LINE OF THE SOUTHEAST QUARTER OF SAID SECTION 24;

THENCE NORTH 89°57'09" EAST, PARALLEL WITH AND 57.00 FEET SOUTH OF SAID NORTH LINE, FOR A DISTANCE OF 74.83 FEET, TO THE PROLONGATION OF THE WEST LINE OF EAST 60.00 FEET OF LOT 24 OF SAID FINAL PLAT;

THENCE SOUTH 00°06'59" WEST, ALONG SAID WEST LINE, FOR A DISTANCE OF 200.14 FEET; THENCE NORTH 89°57'09" EAST, PARALLEL WITH THE NORTH LINE OF THE SOUTHEAST QUARTER OF SAID SECTION 24, FOR A DISTANCE OF 60.03 FEET, TO A POINT ON THE WEST LINE OF LOT 23 OF SAID FINAL PLAT;

THENCE NORTH 00°08'09" EAST, ALONG SAID WEST LINE, FOR A DISTANCE OF 200.14 FEET TO A POINT 57.00 FEET SOUTH OF THE NORTH LINE OF THE SOUTHEAST QUARTER OF SAID SECTION 24;

THENCE NORTH 89°57'09" EAST, PARALLEL WITH AND 57.00 FEET SOUTH OF THE NORTH LINE OF THE SOUTHEAST QUARTER OF SAID SECTION 24, FOR A DISTANCE OF 1129.23 FEET;

THENCE SOUTH 50°04'55" EAST, FOR A DISTANCE OF 19.11 FEET TO A POINT ON THE WEST RIGHT-OF-WAY LINE OF RIVER DRIVE AS RECORDED IN SAID FINAL PLAT;

THENCE SOUTH 00°07'09" WEST, ALONG SAID WEST RIGHT-OF-WAY, FOR A DISTANCE OF 563.37 FEET, TO THE NORTH RIGHT-OF-WAY LINE OF WILDERMUTH AVENUE AS RECORDED IN SAID FINAL PLAT;

THENCE SOUTH 89°58'09" WEST, ALONG SAID NORTH RIGHT-OF-WAY, FOR A DISTANCE OF 116.00 FEET TO THE EAST RIGHT-OF-WAY LINE OF ROCKFORD DRIVE AS RECORDED IN DOCKET 1203, PAGE 437, RECORDS OF MARICOPA COUNTY, ARIZONA;

THE FOLLOWING THREE COURSES ARE ALONG SAID EAST RIGHT-OF-WAY LINE OF ROCKFORD DRIVE:

THENCE NORTH 00°07'09" EAST, FOR A DISTANCE OF 74.97 FEET;

THENCE NORTH 89°57'09" EAST, FOR A DISTANCE OF 12.00 FEET;

THENCE NORTH 00°07'09" EAST, FOR A DISTANCE OF 207.65 FEET TO A POINT ON THE NORTH LINE OF TRACT C OF SAID FINAL PLAT;

THENCE SOUTH 89°57'09" WEST, ALONG SAID NORTH LINE, FOR A DISTANCE OF 104.00 FEET, TO A POINT ON THE EAST LINE OF THE WEST 104.00 FEET OF THE EAST HALF OF TRACT C OF SAID FINAL PLAT;

THENCE SOUTH 00°07'09" WEST, ALONG SAID EAST LINE, FOR A DISTANCE OF 282.59 FEET TO A POINT ON THE NORTH RIGHT-OF-WAY LINE OF WILDERMUTH AVENUE AS RECORDED IN SAID FINAL PLAT;

THENCE SOUTH 89°58'09" WEST, ALONG SAID NORTH RIGHT-OF-WAY, FOR A DISTANCE OF 208.00 FEET TO A POINT ON THE WEST LINE OF THE EAST 104.00 FEET OF THE WEST HALF OF TRACT C OF SAID FINAL PLAT;

THENCE NORTH 00°07'09" EAST, ALONG SAID WEST LINE, FOR A DISTANCE OF 282.53 FEET TO A POINT ON THE NORTH LINE OF TRACT C OF SAID FINAL PLAT;

THENCE SOUTH 89°57'09" WEST, ALONG SAID NORTH LINE, FOR A DISTANCE OF 104.00 FEET TO A POINT ON THE EAST LINE OF THE WEST 104.00 FEET OF TRACT C OF SAID FINAL PLAT;

THENCE SOUTH 00°07'09" WEST, ALONG SAID EAST LINE, FOR A DISTANCE OF 282.50 FEET TO A POINT ON THE NORTH RIGHT-OF-WAY LINE OF WILDERMUTH AVENUE AS RECORDED IN SAID FINAL PLAT;

THENCE SOUTH 89°58'09" WEST, ALONG SAID NORTH RIGHT-OF-WAY, FOR A DISTANCE OF 208.00 FEET TO A POINT ON THE WEST LINE OF THE EAST 104.00 FEET OF TRACT D OF SAID FINAL PLAT;

THENCE NORTH 00°07'09" EAST, ALONG SAID WEST LINE, FOR A DISTANCE OF 282.44 FEET TO A POINT ON THE NORTH LINE OF TRACT D OF SAID FINAL PLAT;

THENCE SOUTH 89°57'09" WEST, ALONG SAID NORTH LINE, FOR A DISTANCE OF 312.00 FEET TO A POINT ON THE EAST LINE OF THE WEST 238.93 FEET OF TRACT D OF SAID FINAL PLAT;

THENCE SOUTH 00°07'09" WEST, ALONG SAID EAST LINE, FOR A DISTANCE OF 188.00 FEET;

THENCE NORTH 89°57'09" EAST, FOR A DISTANCE OF 92.00 FEET TO A POINT ON THE EAST LINE OF THE WEST 92.00 FEET OF THE EAST 416.00 FEET OF TRACT D OF SAID FINAL PLAT;

THENCE SOUTH 00°07'09" WEST, ALONG SAID EAST LINE, FOR A DISTANCE OF 94.37 FEET TO A POINT ON THE NORTH RIGHT-OF-WAY LINE OF WILDERMUTH AVENUE AS RECORDED IN SAID FINAL PLAT;

THENCE SOUTH 89°58'09" WEST, ALONG SAID NORTH RIGHT-OF-WAY, FOR A DISTANCE OF 331.01 FEET TO THE POINT OF BEGINNING.

SAID PARCEL CONTAINS 586,566 SQ.FT., OR 13.466 ACRES, MORE OR LESS.

PROJECT DATA

ZONING DISTRICT(S) AND OVERLAY(S)	R-4 / TOD Table 5-610A Multi-Family	CSS / TOD Table 5-611A Commercial	PAD Proposed MU-4 / TOD / PAD
GENERAL PLAN LAND USE	Mixed-Use	Mixed-Use	Mixed-Use
GENERAL PLAN DENSITY (DU/Ac)	Up to 65	Up to 65	Up to 65
SITE AREA - GROSS	223,015 SF / 5.12 Ac	367,725 SF / 8.44 Ac	590,740 SF / 13.56 Ac
SITE AREA - NET	223,015 SF / 5.12 Ac	363,551 SF / 8.35 Ac	586,566 SF / 13.47 Ac
DWELLING QUANTITY			698 DU
DENSITY (DU/Ac)	40	25	51
BUILDING HEIGHT	60 ft	45 ft	90 ft
BUILDING STEPBACK (Adjacent to SFR Districts)	Yes	Yes	Yes
BUILDING LOT COVERAGE	75%	75%	75%
SITE LANDSCAPE COVERAGE	25%	25%	
AT GRADE			19.6%
AT DECK PARK (2nd Floor)			5.6%
COMBINED			25.2%
BUILDING SETBACKS *			
FRONT (APACHE BLVD.)	10 ft Min / 20 ft Max	0 ft Min / 6 ft Max	0 ft Min / 20 ft Max
SIDE (RIVER DR.)	10 ft	0 ft	0 ft Min / 20 ft Max
REAR (WILDERMUTH AVE.)	10 ft	10 ft	0 ft Min / 20 ft Max
SIDE (INTERIOR LOT LINES)	5 ft	0 ft #	0 ft
SIDE (WEST PROPERTY LINE)	10 ft	10 ft	10 ft Min
STREET SIDE - PARKING AND MANUEVERING	20 ft	20 ft	20 ft
VEHICLE PARKING QUANTITY REQUIRED			1207
RESIDENTIAL			
1 Bed (444 Units / 444 Beds)			333 (0.75 SP/Bed)
2 Bed (184 Units / 368 Beds)			276 (0.75 SP/Bed)
3 Bed (60 Units / 180 Beds)			135 (1.75 SP/Bed)
Live-Work 1 Bed (10 Units / 10 Beds)			8 (1.75 SP/Bed)
GUEST (698 Units)			140 (0.20 SP/Unit)
TOTAL RESIDENTIAL			892
COMMERCIAL			
Bar			25 (1 SP / 50 SF) #
Restaurant			157 (1 SP / 75 SF)
Gym / Yoga			56 (1 SP / 125 SF)
Office / Retail			77 (1 SP / 300 SF) #
TOTAL COMMERCIAL			315
VEHICLE PARKING QUANTITY PROVIDED			1385
BICYCLE PARKING QUANTITY REQUIRED			717
RESIDENTIAL			
1 Bed (444 Units)			333 (0.75 SP/Unit)
2 Bed (184 Units)			138 (0.75 SP/Unit)
3 Bed (60 Units)			60 (1.00 SP/Unit)
Live-Work 1 Bed (10 Units)			8 (0.75 SP/Unit)
GUEST (698 Units)			140 (0.20 SP/Unit)
TOTAL RESIDENTIAL			679
COMMERCIAL			
Bar			5 (1 SP / 500 SF)
Restaurant			24 (1 SP / 500 SF)
Gym / Yoga			4 (1 SP / 2,000 SF)
Office / Retail			5 (1 SP / 7,500 SF)
TOTAL COMMERCIAL			38
BICYCLE PARKING QUANTITY PROVIDED			736
USES			1,333,878 SF
Residential			954,015 SF
Parking Garages			289,555 SF
Storage & Utility			30,742 SF
Commercial			
Bar			2,500 SF
Restaurant			11,800 SF
Gym / Yoga			7,000 SF
Office / Retail			38,166 SF
Total Commercial			59,466

* This PAD defines the front property line as Apache Blvd., not River Dr.
 # Parking waived for 50% of floor area, not to exceed 2,500 SF of floor area
 # Parking waived for 50% of floor area, not to exceed 30,000 SF of floor area
 # 10 ft Min adjacent to residentially zoned property

GENERAL NOTES

1. PARKING FOR RESIDENTIAL UNITS PROVIDED WITHIN EACH SECURED / RESERVED BUILDING PARKING GARAGE. COMMERCIAL USERS AND GUESTS DO NOT HAVE ACCESS TO RESIDENTIAL PARKING GARAGES.
2. BICYCLE SPACES FOR RESIDENTIAL UNITS PROVIDED WITHIN EACH BUILDING PARKING GARAGE, AS WELL AS IN A DEDICATED BIKE STORAGE / REPAIR ROOM AT GRADE LEVEL OF EACH BUILDING.

DS151102

PL160097

REC16057

REC16057

PL160097

DS151102

K & L HOMES, LLC
 4122 N. OVAL CENTER PLAZA
 SCOTTSDALE, AZ 85251
 PH: 480-970-9800



Revisions		
#	Description	Date

OWNERSHIP OF DOCUMENTS
 DRAWING AND SPECIFICATIONS ARE INSTRUMENTS OF SERVICE AND SHALL REMAIN THE PROPERTY OF THE ARCHITECT UNLESS THE PROJECT FOR WHICH THEY WERE PREPARED IS TO BE USED ON OTHER PROJECTS OR EXTENDING TO THIS PROJECT EXCEPT BY AGREEMENT IN WRITING AND WITH APPROPRIATE CONSIDERATION TO K & L HOMES, LLC.


JOB NUMBER:
 DRAWN BY: AD
 CHECKED BY: KS
 ISSUE DATE: 07/13/2016



PAD 2

PAD / DPR #4

PLANNED AREA DEVELOPMENT OVERLAY FOR EASTLINE VILLAGE SITE PLAN

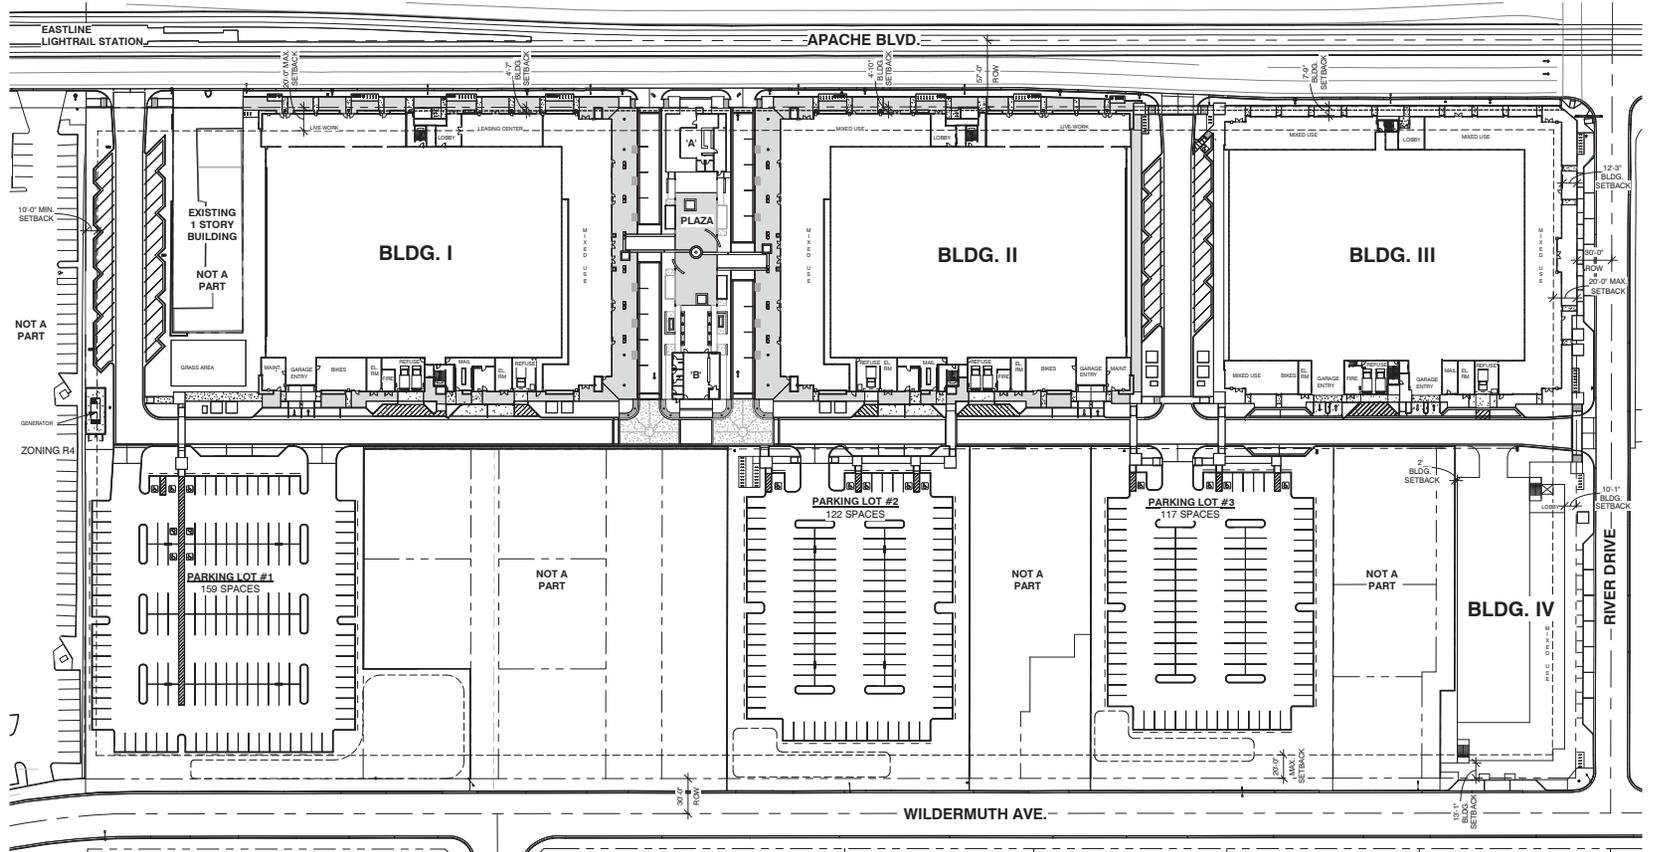

① SITE PLAN
1" = 50'-0"



DS151102

PL160097

REC16057

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PL160097

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K & I HOMES, LLC
4422 N. OVAL CENTER PLAZA
SCOTTSDALE, AZ 85251
PH: 480-970-9800



uhdc
URBAN HOME
DEVELOPMENT
CORPORATION



EASTLINE
VILLAGE
LIVE - WORK - PLAY
APACHE BLVD. REDEVELOPMENT
TEMPE, ARIZONA

Revisions		
#	Description	Date
OWNERSHIP OF DOCUMENTS		
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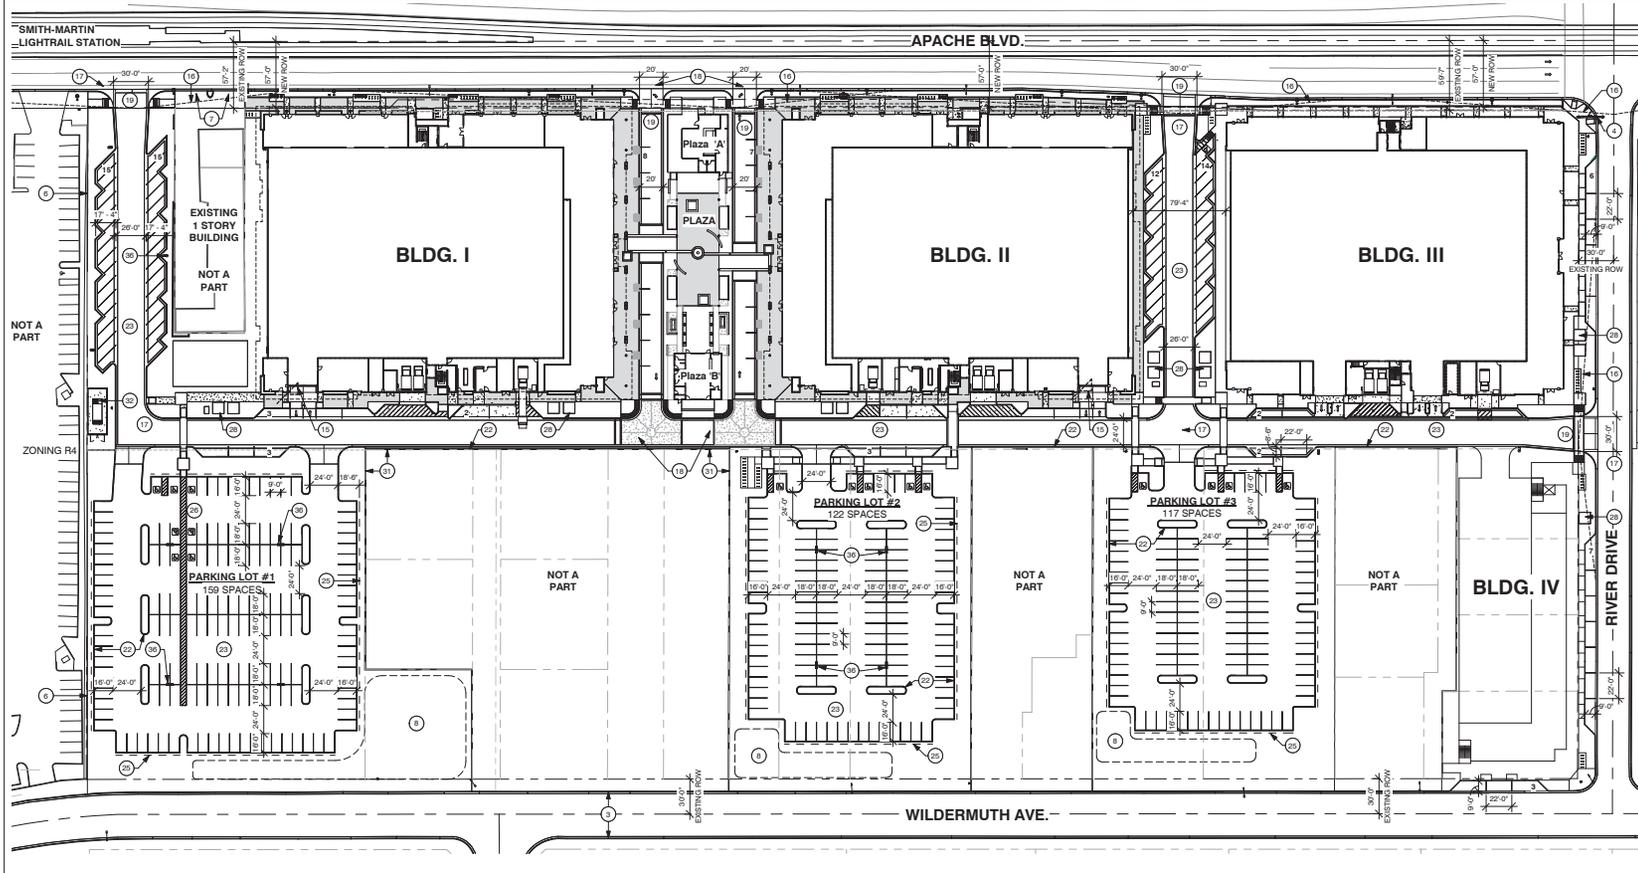


SHEET TITLE:
Site Plan

SHEET NUMBER:

PAD 3

PAD / DPR #4



SITE KEYNOTES

- EXIST VERTICAL CONC. CURB AND GUTTER
- EXIST. ROLLED CONC. CURB AND GUTTER
- EXIST. TRAFFIC SIGNAL LIGHT
- EXIST. ACCESSIBLE SIDEWALK RAMPS
- EXIST. 2" CMU FENCE
- STUCCO AND PAINT ON PROJECT SIDE
- RETURN TYPE DRIVEWAY ENTRANCE PER COT STD. DET. T-319 WITH SIDEWALK SCOOP RAMP PER DET. T-348 - WIDTH AS SHOWN
- 8" CMU WALL - 30" H W/ 4" CAP
- 10'0" x 10'0" CLEAR VISUAL TRIANGLE
- SIGHT DISTANCE LINE
- FIRST TRUCK TURNING RADIUS (20' / 45')
- TRUCK TURNING RADIUS (SU 30)
- RETURN TYPE DRIVEWAY ENTRANCE PER COT STD. DET. T-319 WITH SIDEWALK SCOOP RAMP PER DET. T-348 - WIDTH AS SHOWN
- VERT. CONC. CURB AND GUTTER
- 4" VERT. CONC. CURB
- TEMP. 6" EXTRUDED CONCRETE CURB
- ASPHALT PAVING
- 4" W PARKING STRIPE
- 2" VEHICLE OVERHANG
- ACCESSIBLE SIGNAGE AND STRIPING PER COT STD. DET. T-366
- LOADING AND DELIVERY ZONE - 6" REINFORCED CONCRETE SLAB
- PROPOSED SSP TRANSFORMER LOCATION
- BIKE RACK PER COT STD. DET. T-578 (# OF BIKES AS SHOWN)
- LANDSCAPE AREA
- TEMPORARY 2' HIGH CMU SITE/SCREEN WALL GENERATOR WITH 10' H CMU SCREEN WALL
- CONCRETE SIDEWALK
- ACCESSIBLE CURB RAMP
- SIDEWALK PER TDD STANDARD ALONG STREET FRONTAGE
- POLE LIGHT - SEE PHOTOMETRICS

VICINITY MAP

MASTER SITE PLAN - Ground Level
 SCALE: 0" = 1" = 50' - 0"
 0' 25' - 0" 50' - 0" 100' - 0"

K & I HOMES, LLC
 4422 N. DAVIS CENTER PLAZA
 SUITE 202
 SCOTTSDALE, AZ 85251
 PH: 480-970-9800

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DMB

EASTLINE
 VILLAGE
 LIVE - WORK - PLAY
 APACHE BLVD. REDEVELOPMENT
 TEMPE, ARIZONA

GENERAL SITEPLAN NOTES

- DEVELOPMENT AND USE OF THIS SITE WILL CONFORM WITH ALL APPLICABLE CODES AND ORDINANCES.
- NO STRUCTURES, LIGHTS, POLES, TREES, DEEP ROOTED PLANTS, ETC. ALLOWED IN EASEMENTS OR ABOVE UNDERGROUND UTILITIES
- ALL NEW OR EXISTING OVERHEAD UTILITIES ON OR ADJACENT TO SITE MUST BE PLACED UNDERGROUND.
- WITHIN SIGHT DISTANCE TRIANGLES AT DRIVEWAY TO STREET INTERSECTIONS:
 - TREES SHALL BE TRIMMED TO 1' HEIGHT CLEAR FROM GROUND
 - SHRUBS SHALL BE TRIMMED AND MAINTAINED AT 2' HIGH MAXIMUM
 - NO MULTITRUNK TREES ALLOWED
- OWNERS OF PROPERTY ADJACENT TO PUBLIC RIGHT OF WAY SHALL HAVE THE RESPONSIBILITY FOR MAINTAINING ALL LANDSCAPING LOCATED WITHIN THE RIGHT-OF-WAYS. ACCORDANCE WITH APPROVED PLANS.
- AFTER FINAL APPROVAL THE PROJECT WILL BE INSPECTED FOR ZONING COMPLIANCE DURING CONSTRUCTION AND PRIOR TO OCCUPANCY.
- ALL ROOFTOP EQUIPMENT AND SATELLITE DISHES SHALL BE SCREENED TO THE HEIGHT OF THE TALLEST EQUIPMENT.
- ALL SIGNAGE REQUIRES A SEPARATE REVIEW AND PERMIT.
- ANY EXISTING BROKEN OR OUT OF GRADE CURBS AND SIDEWALK ON THE PROJECT SITE, AS WELL AS, ANY NEW CURB OR SIDEWALK DAMAGED DURING CONSTRUCTION SHALL BE REPLACED.

LEGAL DESCRIPTION

APPROXIMATE LEGAL DESCRIPTION:
 THOSE PORTIONS OF THE FINAL PLAT OF BUENA PARK PLAT 2, ACCORDING TO BOOK 33 OF MAPS, PAGE 38, RECORDS OF MARICOPA COUNTY, ARIZONA, BEING LOCATED IN THE SOUTHEAST QUARTER OF SECTION 24, TOWNSHIP 1 NORTH, RANGE 4 EAST OF THE GILA AND SALT RIVER BASE AND MERIDIAN, MARICOPA COUNTY, ARIZONA

PHASE I & II INCLUDES 27 DIFFERENT PARCELS THAT WILL BE COMBINED WITH NEW SUBDIVISION PLAT

133-02-044E / 133-02-044A / 133-02-043A / 133-02-041 / 133-02-040 / 133-02-039 / 133-02-038 / 133-02-027 / 133-02-026A / 133-02-026A / 133-02-025A / 133-02-023A / 133-02-023A / 133-02-021A / 133-02-017C / 133-02-017E / 133-02-017D / 133-02-010 / 133-02-009 / 133-02-009 / 133-02-002 / 133-02-009 / 133-02-009 / 133-02-000 / 133-02-001

PROJECT INFO

PROJECT NAME: EASTLINE VILLAGE PHASE I - II

SITE ADDRESS:
 BLDG I: 2025 E. APACHE BLVD. (PROPOSED)
 PLAZA A: 2035 E. APACHE BLVD. (PROPOSED)
 PLAZA B: 2045 E. APACHE BLVD. (PROPOSED)
 BLDG II: 2055 E. APACHE BLVD. (PROPOSED)
 BLDG III: 2065 E. APACHE BLVD. (PROPOSED)
 BLDG IV: 1330 S. RIVER DR. (PROPOSED)

PROPOSED USE / SCOPE OF WORK: REDEVELOPMENT / NEW MIXED USE URBAN NEIGHBORHOOD.
 BUILDINGS I, II, III: 5 LEVELS OF LIVING UNITS OVER 2 LEVEL PARKING GARAGE AND GROUND FLOOR COMMERCIAL USE
 BUILDING IV: 3 LEVELS OF LIVING UNITS OVER GROUND FLOOR PARKING GARAGE AND COMMERCIAL USE
 PLAZA A & B: 1 STORY BAR/RESTAURANT

VARIANCES REQUESTED: NONE

USE PERMIT REQUIRED: PLAZA B (FUTURE BAR), PROCESSED SEPARATELY

PARCEL SIZE: GROSS: 171,560.940 SF = 13.56 ACRES +/-; NET: 586,556.56 SF = 13.47 ACRES

GENERAL PLAN 2040: PROJECTED LAND USE: MIXED USE; PROJECTED DENSITY: HIGH DENSITY (UP TO 65 DU / ACRE)

ZONING: EXISTING ZONING: C5S TDD; COMMERICAL SHOPPING AND SERVICES; PROPOSED ZONING: R4 TDD; MULTI-FAMILY RESIDENTIAL GENERAL; OVERLAY DISTRICT: TOD/PAD; TRANSPORTATION / PLANNED AREA DEVELOPMENT

BUILDING AREAS & CONSTRUCTION TYPE: GROSS SF PER 2012 IBC (SEE APP A.5.4)

BUILDING	P1/GF	P2	2ND	3RD	4TH	5TH	6TH	TOTAL	TYPE
BLDG I	76,119	59,418						135,537	I-A
BLDG II	27,645	27,509	27,702	27,509	29,943			140,308	II-B
BLDG III	28,018	28,018	28,168	28,018	29,730			141,952	III-B
BLDG IV	76,119	59,418						135,537	I-A
BLDG I	27,645	27,509	27,702	27,509	29,943			140,308	II-B
BLDG II	28,018	28,018	28,168	28,018	29,730			141,952	III-B
BLDG III	45,032	22,912						115,076	III-B
BLDG I	26,903	26,903	26,903	26,903	26,903			134,515	III-B
BLDG II	26,945	26,945	26,945	26,945	26,945			134,725	III-B
BLDG III	29,919							29,919	V-A
BLDG I	2,000	26,903	26,903	26,903				80,709	V-A
PLAZA A	2,000							2,000	V-B
PLAZA B	1,600							1,600	V-B

TOTAL ALL BUILDINGS: 802,709 SF

TOTAL GROUND FLOOR (P1/GF): 231,386 SF

NET LOT COVERAGE: 231,386 / 586,556 SF = 39.44 %

OCCUPANCY GROUP (SEE SHEETS A.6.3): MIXED USE APARTMENT UNITS ASSEMBLY (BAR/RESTAURANT)

FIRE SPRINKLERS: YES - FULL NFPA 13, PER IBC SEC. 903.3.1.1

FIRE ALARM: YES - PER IBC SEC. 907

ALLOWABLE AREAS AND HEIGHT (SEE SHEETS A.8.3): ACTUAL

BLDG I, II & III	PER FLOOR	TOTAL AREA	STORIES	HEIGHT	STORIES / HEIGHT
BLDG I	UNLIMITED	UNLIMITED	UNLIMITED	2'	21'
BLDG II	41,280	123,840	4 + 1 = 5	55' + 20' = 75'	5 / 74'
BLDG III	41,280	123,840	4 + 1 = 5	55' + 20' = 75'	5 / 74'
BLDG IV	28,000	65,600	3 + 1 = 4	50' + 20' = 70'	4 / 50'
PLAZA A&B	6,000	18,000	1 + 1 = 2	20' + 20' = 40'	1 / 20'

UNIT MIX & NET LIVABLE AREAS (SEE SHEETS A.4.8.3):

APARTMENTS:

UNIT TYPE	NUMBER OF UNITS	AVG. UNIT AREA	AVG. BALCONY AREA
1 BED/1.5 BATH	444	841 SF	91 SF
2 BED/2.5 BATH	184	1,284 SF	114 SF
3 BED/3.5 BATH	60	1,693 SF	162 SF
TOTAL UNITS	688		

LIVE-WORK CONDOMINIUMS:

UNIT TYPE	NUMBER OF UNITS	COMMERCIAL	LIVING	BALCONY
1 BED/1.5 BATH	10	645 SF	700 SF	125 SF
TOTAL LIVING UNITS:	698			

TYPE 'A' UNITS: REQUIRED IBC SEC. 1107.6.2.1.1; 2% OF TOTAL = 698 x 2% = 13.96 PROVIDED = 14 UNITS

ALL OTHER UNITS MEET TYPE 'B' ACCESSIBILITY STANDARDS

DENSITY - MAXIMUM ALLOWED: 65 DU / NET ACRE

DENSITY - CURRENTLY PROPOSED: 698 UNITS / 13.56 AC = 51.47 DU / GROSS ACRE

OPEN SPACE PROVIDED ON-SITE: AREA % OF NET SITE

TYPE	AREA	% OF NET SITE
SITE/GROUND LEVEL OPEN SPACE (SEE A1.9)	10,654 SF	1.8 %
CENTER PLAZA (LANDSCAPE/HARDSCAPE)	62,090 SF	10.6 %
LANDSCAPE PLANTERS	42,209 SF	7.2 %
SIDEWALK/HARDSCAPE (FROM BUILDING TO CURB OR P.L.)	114,963 SF	19.6 %
TOTAL SITE/GROUND FLOOR	219,916 SF	37.6 %

DECK PARKS / 2ND FLOOR

TYPE	AREA	% OF NET SITE
DECK PARKS (11,100 SF EA X 3)	33,300 SF	5.6 %
TOTAL SITE AND DECK PARKS	253,216 SF	43.2 %

PRIVATE OPEN SPACE/RESIDENTS

TYPE	AREA	% OF NET SITE
PRIVATE BALCONIES AND PATIOS (105 SF AVG. UNIT)	72,240 SF	12.3 %

ROW IMPROVEMENTS PROVIDED:

TYPE	AREA	% OF NET SITE
LANDSCAPE PLANTERS:	16,315 SF	2.8 %
SIDEWALK/HARDSCAPE:	3,952 SF	0.7 %
TOTAL	20,267 SF	3.5 %

Parking Required - RESIDENTIAL VEHICLES

Category	Required	Provided	Surplus
Building 1	187	187	0
Building 2	187	187	0
Building 3	187	187	0
Building 4	187	187	0
Total	748	748	0

Parking Required - GUEST VEHICLES

Category	Required	Provided	Surplus
Building 1	187	187	0
Building 2	187	187	0
Building 3	187	187	0
Building 4	187	187	0
Total	748	748	0

Total Required - RESIDENTIAL & GUEST VEHICLES: 892

Total Provided - RESIDENTIAL & GUEST VEHICLES: 878

Accessible Spaces required: 2% of total spaces provided = 18

Parking for residential units provided within each sub-developed building parking garage: Commercial users and Guests do not have access to residential parking spaces. Bicycle spaces for residential units provided within each building, as well as in a dedicated bike storage/parking room at grade level of each building.

Parking Required - COMMERCIAL & GUEST VEHICLES

Category	Required	Provided	Surplus
Commercial	187	187	0
Guest	187	187	0
Total	374	374	0

Total Required - COMMERCIAL & GUEST VEHICLES: 468

Total Provided - COMMERCIAL & GUEST VEHICLES: 477

Accessible Spaces required: 2% of total spaces provided = 18

Total Required - ENTIRE PROJECT VEHICLES: 1,360

Total Provided - ENTIRE PROJECT VEHICLES: 1,255

Revisions

#	Description	Date

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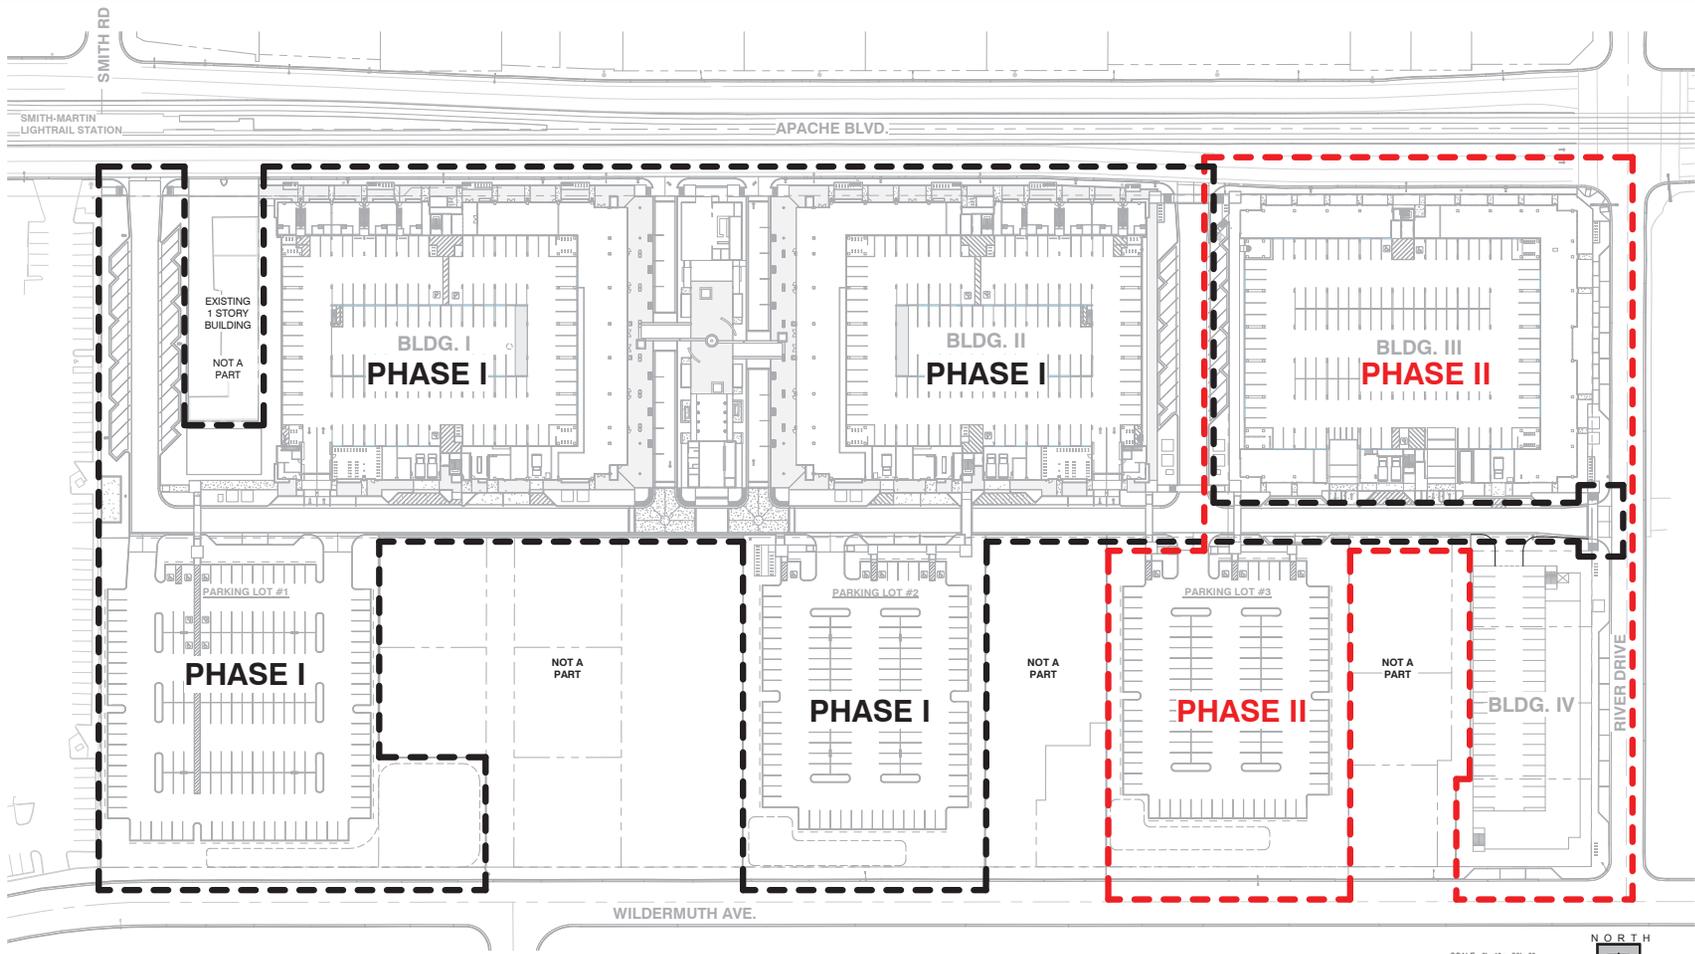
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SHEET TITLE: Master Site Plan

SHEET NUMBER: A1.1

PAD / DPR #4



1 SITE PLAN - PHASING PLAN
1" = 50'-0"


SCALE: 0' - 1" = 50'-0"
0' 25' 50' 100' 0"



SITE PLAN PHASING GENERAL NOTES

1. PHASE I & II ARE PART OF INITIAL REZONE / PAD
2. FUTURE PHASE REZONE / PAD AMENDMENT UNDER SEPARATE SUBMITTAL AT A LATER DATE - TBD

VICINITY MAP

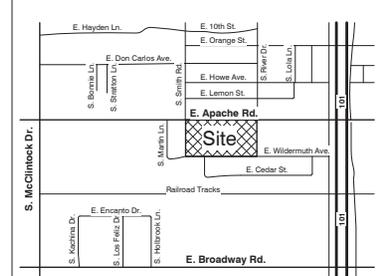

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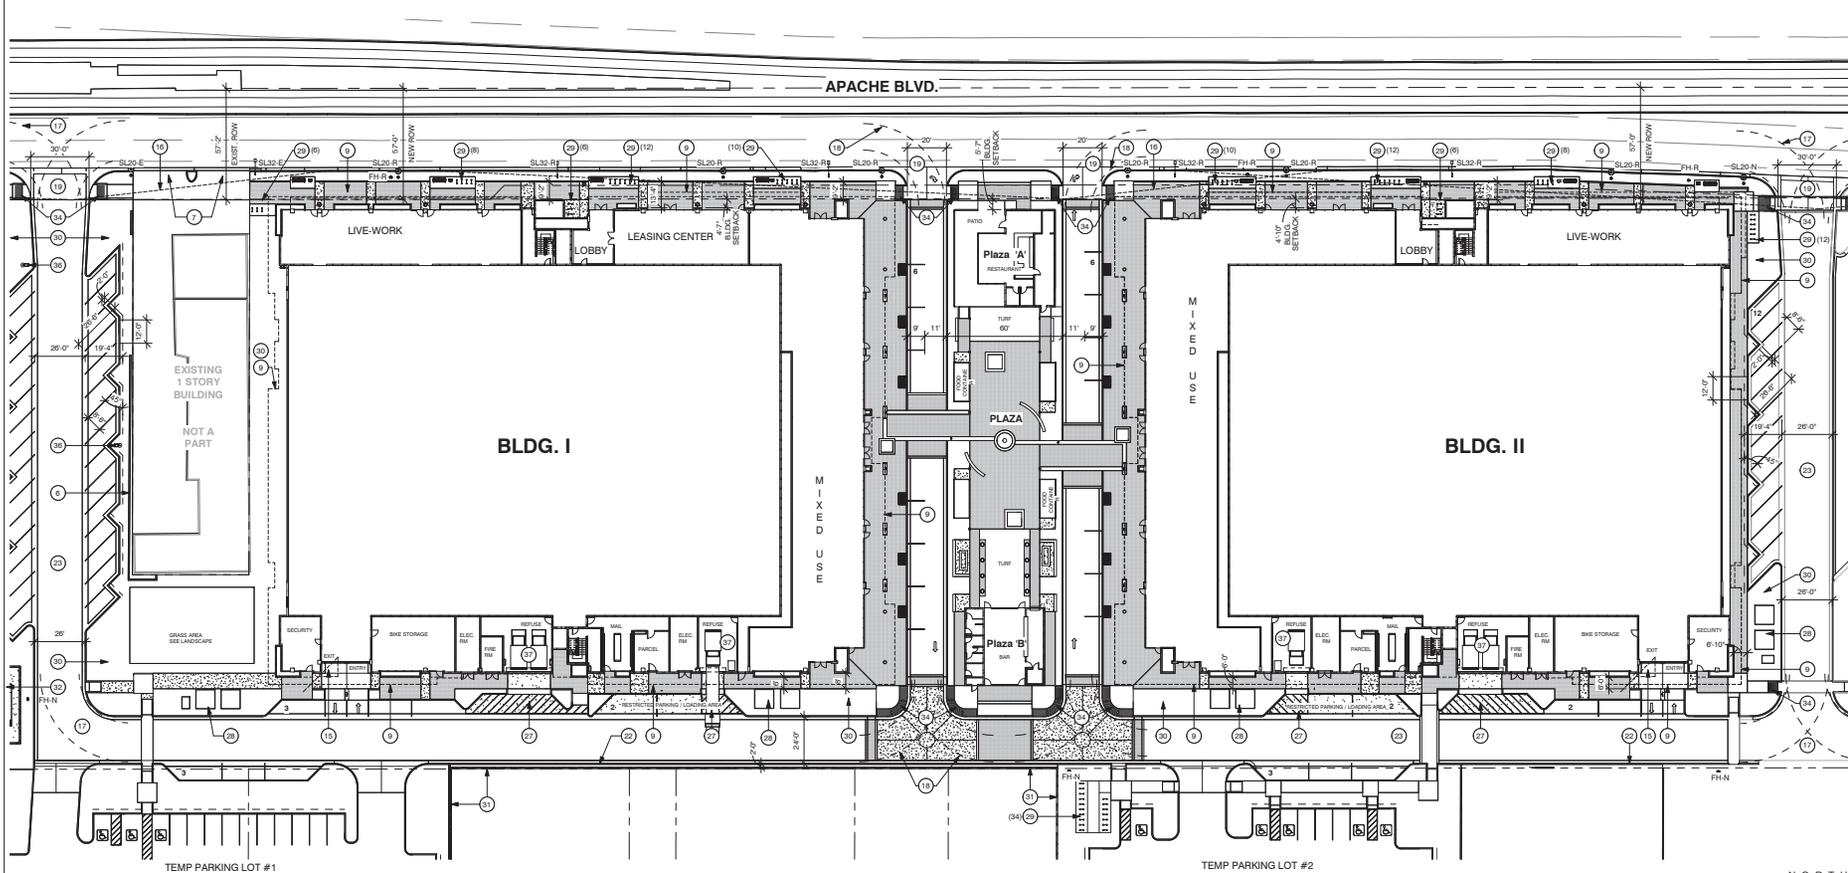
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SHEET TITLE:
Site Plan - Phasing Plan
SHEET NUMBER:

A1.2

PAD / DPR #3




1 SITE PLAN - PHASE I - BLDG I & BLDG II - Ground Level
1" = 30'-0"



LEGEND	
	- ENHANCED HARDSCAPE (PAVERS, EXPOSED AGGREGATE AND/OR COLORED CONCRETE)
	- PAVEMENT, SIDEWALKS, AND PLAZA
	- EXACT TYPE, COLOR AND PATTERN TBO.
ABBREVIATIONS:	
FH	FIRE HYDRANT
MH	MANHOLE
SL20	STREETLIGHT 20H (COT. DET. T-646)
SL30	STREETLIGHT 30H (COT. DET. T-652)
E	EXISTING
R	EXISTING - RELOCATED WHERE SHOWN
N	NEW

SITE PLAN KEYNOTES	
1. EXISTING VERTICAL CONC. CURB AND GUTTER	29. BIKE RACK PER COT STD. DET. T-678 (# OF BIKES AS SHOWN)
2. EXISTING CONC. SIDEWALK	30. LANDSCAPE AREA
3. EXISTING ROLLED CONC. CURB AND GUTTER	31. (TEMPORARY) 8H CMU SITE SCREEN WALL
4. EXISTING TRAFFIC SIGNAL LIGHT	32. GENERATOR WITH 10' H CMU SCREEN WALL
5. EXISTING ACCESSIBLE SIDEWALK RAMPS	33. CONCRETE SIDEWALK
6. EXISTING 8H CMU FENCE, STUCCO AND PAINT ON PROJECT SIDE	34. ACCESSIBLE CURB RAMP
7. EXISTING DRIVEWAY	35. SIDEWALK - PER TOD STANDARD ALONG STREET FRONTAGE
8. RETENTION AREA - REFER TO CIVIL	36. POLE LIGHT - SEE PHOTOMETRICS
9. LINE OF SHADE CANOPY ABOVE OR CONCRETE DECK ABOVE	37. TRASH / RECYCLE COMPACTOR
10. 8" CMU WALL - 30'H W/ 4" CAP	38.
11.	39.
12.	40.
13.	
14. 10' 0" x 10' 0" CLEAR VISION TRIANGLE	
15. SIGHT DISTANCE LINE.	
16. FIRE TRUCK TURNING RADIUS (25' INSIDE / 45' OUTSIDE)	
17. TRUCK TURNING RADIUS (30' INSIDE)	
18. RETURN TYPE DRIVEWAY ENTRANCE PER COT STD. DET. T-319 WITH SIDEWALK SCOOP	
19. RAMP PER DET. T-348 - WIDTH AS SHOWN	
20. VERT. CONC. CURB AND GUTTER	
21. 6" VERT. CONC. CURB	
22. TEMPORARY 6" EXTRUDED CONCRETE CURB	
23. ASPHALT PAVING	
24. 4" W PARKING STRIPE	
25. 2" VEHICLE OVERHANG	
26. ACCESSIBLE SIGNAGE AND STRIPING PER COT STD. DET. T-380	
27. LOADING AND DELIVERY ZONE - 6" REINFORCED CONCRETE SLAB	
28. PROPOSED SRP TRANSFORMER LOCATION	

GENERAL NOTES
1. PLAZA BUILDINGS 'A' & 'B' AND ALL FOOD CONTAINER BUILDINGS UNDER SEPERATE DEVELOPMENT PLAN REVIEW AT A LATER DATE.
2. PUBLIC ART TO BE PROVIDED IN PLAZA AREA BETWEEN BUILDINGS I & II IN COMPLIANCE WITH ZDC SEC. 4-407. LOCATION AND TYPE TO BE DETERMINED.

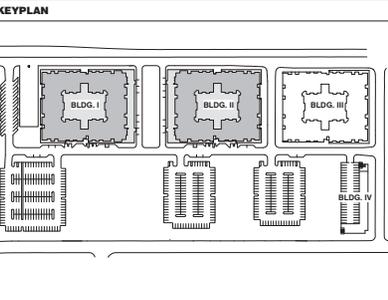

K & I HOMES, LLC
4422 N. OVAL CENTER PLAZA
SUITE 202
SCOTTSDALE, AZ 85261
PH: 480-970-8800



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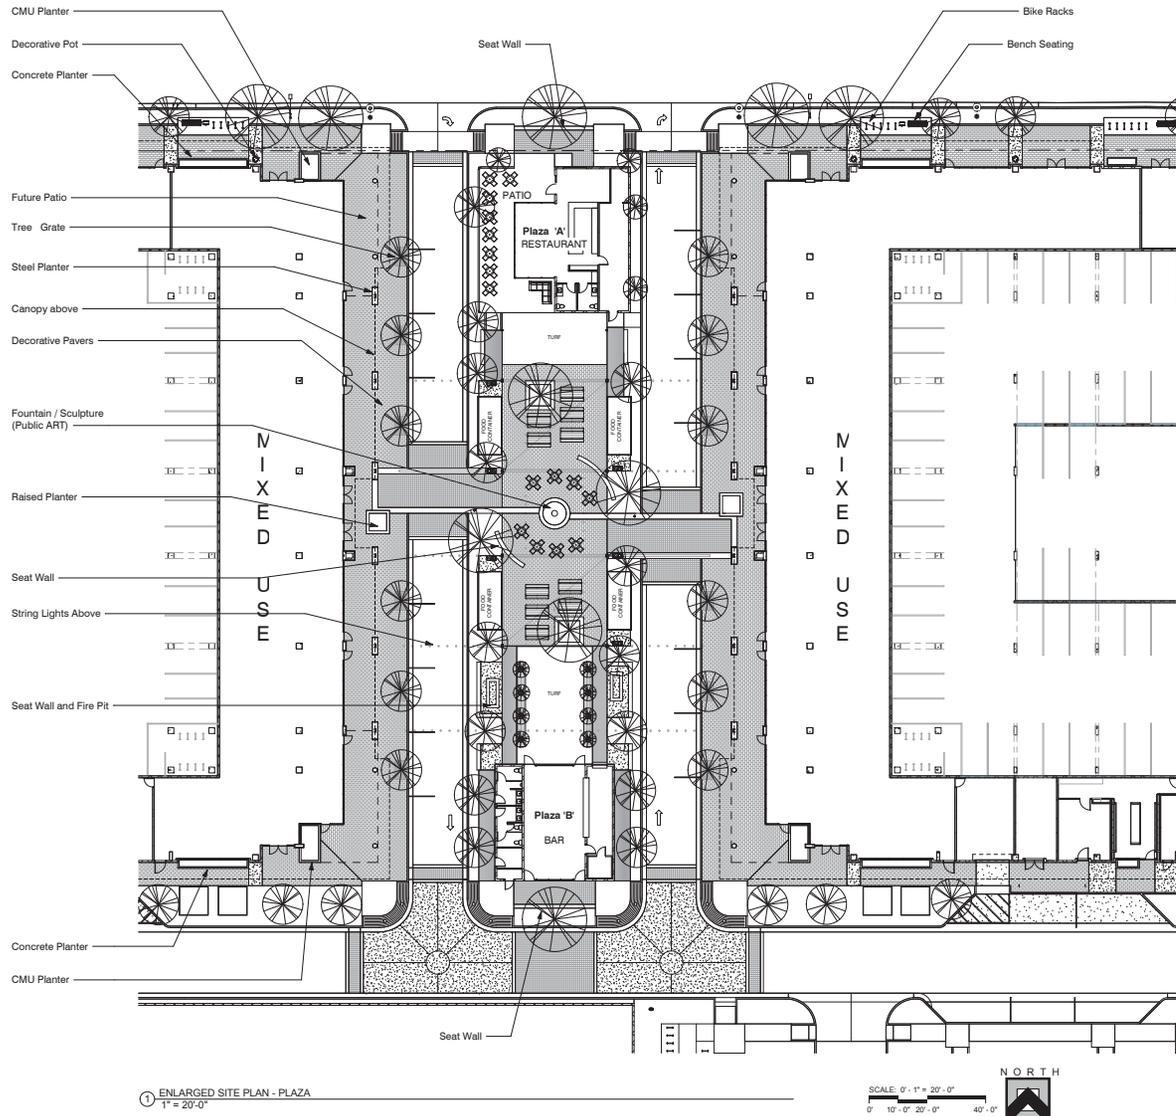
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SHEET TITLE:
Enlarged Site Plan - Phase I - Ground Lvl
SHEET NUMBER:

A1.4.1
PAD / DPR #4



1 ENLARGED SITE PLAN - PLAZA
1" = 20'-0"

NOTE:
PLAZA BUILDINGS 'A' & 'B' AND ALL FOOD CONTAINER BUILDINGS
UNDER SEPRATE DEVELOPMENT PLAN REVIEW AT LATER DATE



Street Food Containers
Character Images

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4422 N. GAVO CENTER PLAZA
SUITE 202
SCOTTSDALE, AZ 85251
PH: 480-970-8800



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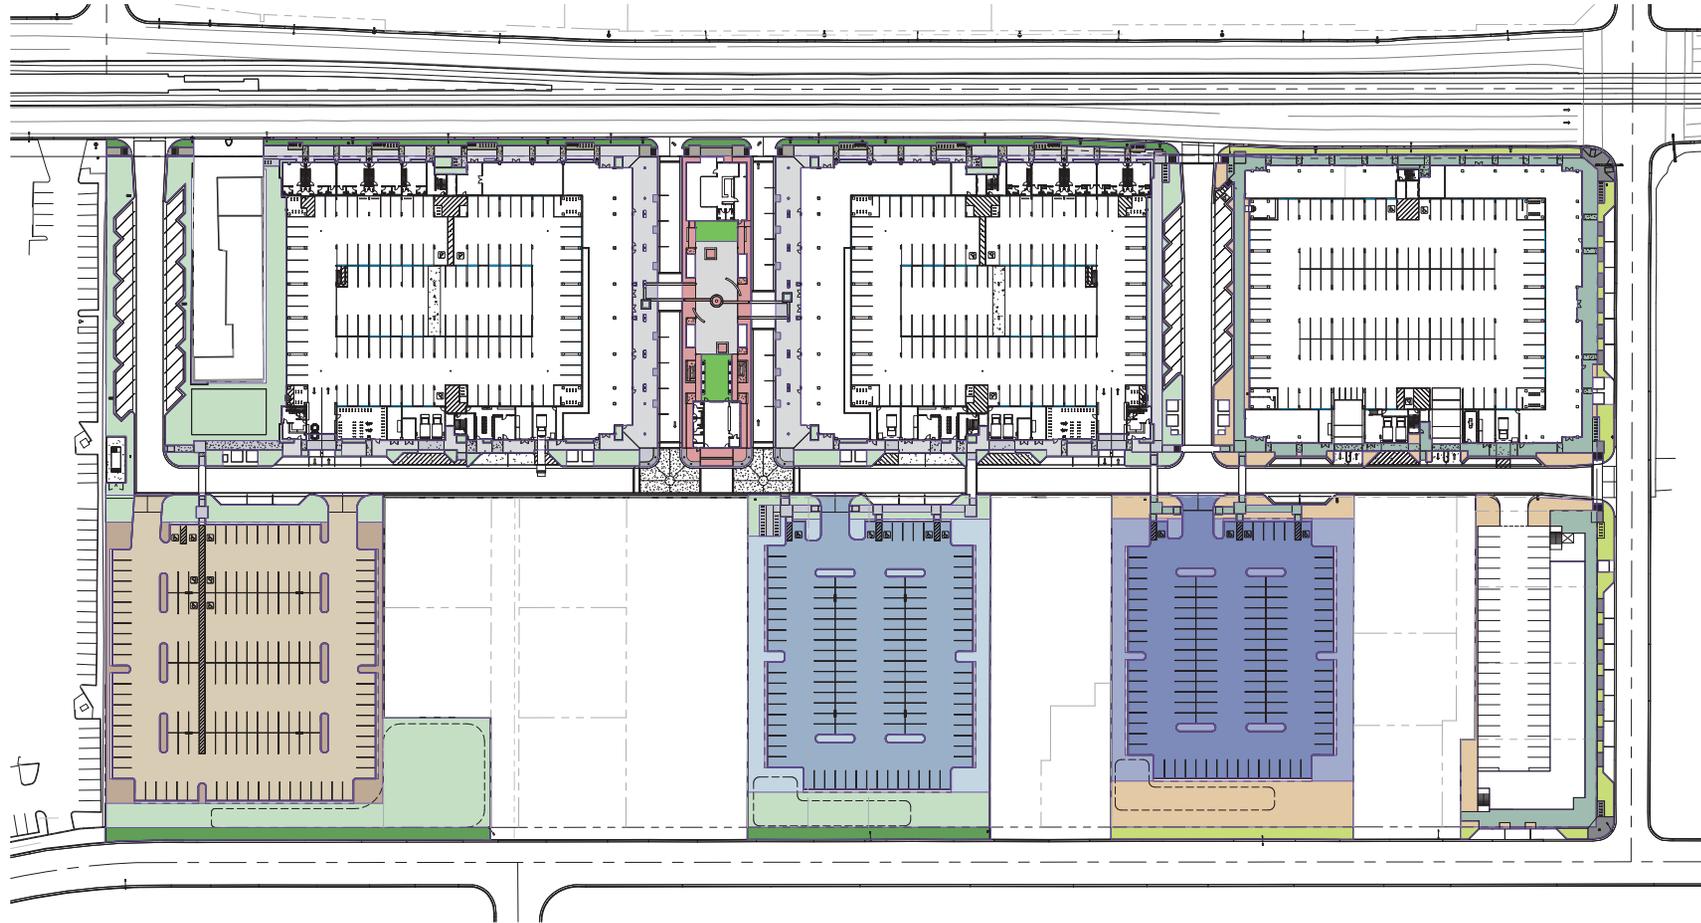
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SHEET TITLE:
Enlarged Site Plan - Plaza

SHEET NUMBER:

A1.4.3

PAD / DPR #4



Open Space Areas
1" = 50'-0"



Open Space Legend

- Hardscape
- Landscape
- Plaza Landscape / Hardscape
- ROW - Hardscape
- ROW - Landscape
- Phase II - Landscape
- Phase II - R.O.W. Landscape
- Phase II - R.O.W. Hardscape
- Phase II - Hardscape
- Parking Lot #1 - Landscape
- Parking Lot #1 - Paving
- Parking Lot #2 - Landscape
- Plaza Landscape (Turf)
- Parking Lot #2 - Paving
- Parking Lot #3 - Landscape
- Parking Lot #3 - Paving

PHASE I - NET SITE AREA: 410,659 sf = 9.43 Acres

OPEN SPACE AREAS - PHASE I		
Area Designation	Area	% OF NET AREA
Hardscape	25,263 SF	6.2%
Landscape	45,953 SF	11.2%
Plaza Landscape (Turf)	1,697 SF	0.4%
Plaza Landscape / Hardscape	8,967 SF	2.2%
Grand total	81,779 SF	20.0%

ROW IMPROVEMENTS - PHASE I

Area Designation	Area
ROW - Hardscape	7105 SF
ROW - Landscape	9417 SF
Grand total	16,522 SF

OVERALL - NET SITE AREA: 586,566 sf = 13.47 Acres

OPEN SPACE AREAS - PHASE I & II		
Area Designation	Area	% OF NET AREA
Hardscape	25,263 SF	4.3%
Landscape	45,953 SF	7.8%
Phase II - Hardscape	16,945 SF	2.9%
Phase II - Landscape	16,237 SF	2.8%
Phase II - R.O.W. Landscape	1,697 SF	0.3%
Phase II - R.O.W. Hardscape	8,967 SF	1.5%
Grand total	114,962 SF	19.6%

ROW IMPROVEMENTS - PHASE I & II

Area Designation	Area
ROW - Landscape	9417 SF
ROW - Hardscape	7105 SF
Phase II - R.O.W. Landscape	6,999 SF
Phase II - R.O.W. Hardscape	2,577 SF
Grand total	26,098 SF

OPEN SPACE AREAS - Parking Lot #1

Area Designation	Area
Parking Lot #1 - Paving	51107 SF
Parking Lot #1 - Landscape	5177 SF
Grand total	56284 SF

10.1%

OPEN SPACE AREAS - Parking Lot #2

Area Designation	Area
Parking Lot #2 - Paving	37642 SF
Parking Lot #2 - Landscape	1911 SF
Grand total	46553 SF

24.7%

OPEN SPACE AREAS - Parking Lot #3

Area Designation	Area
Parking Lot #3 - Paving	36263 SF
Parking Lot #3 - Landscape	8317 SF
Grand total	44580 SF

25.1%

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SUITE 202
SCOTTSDALE, AZ 85251
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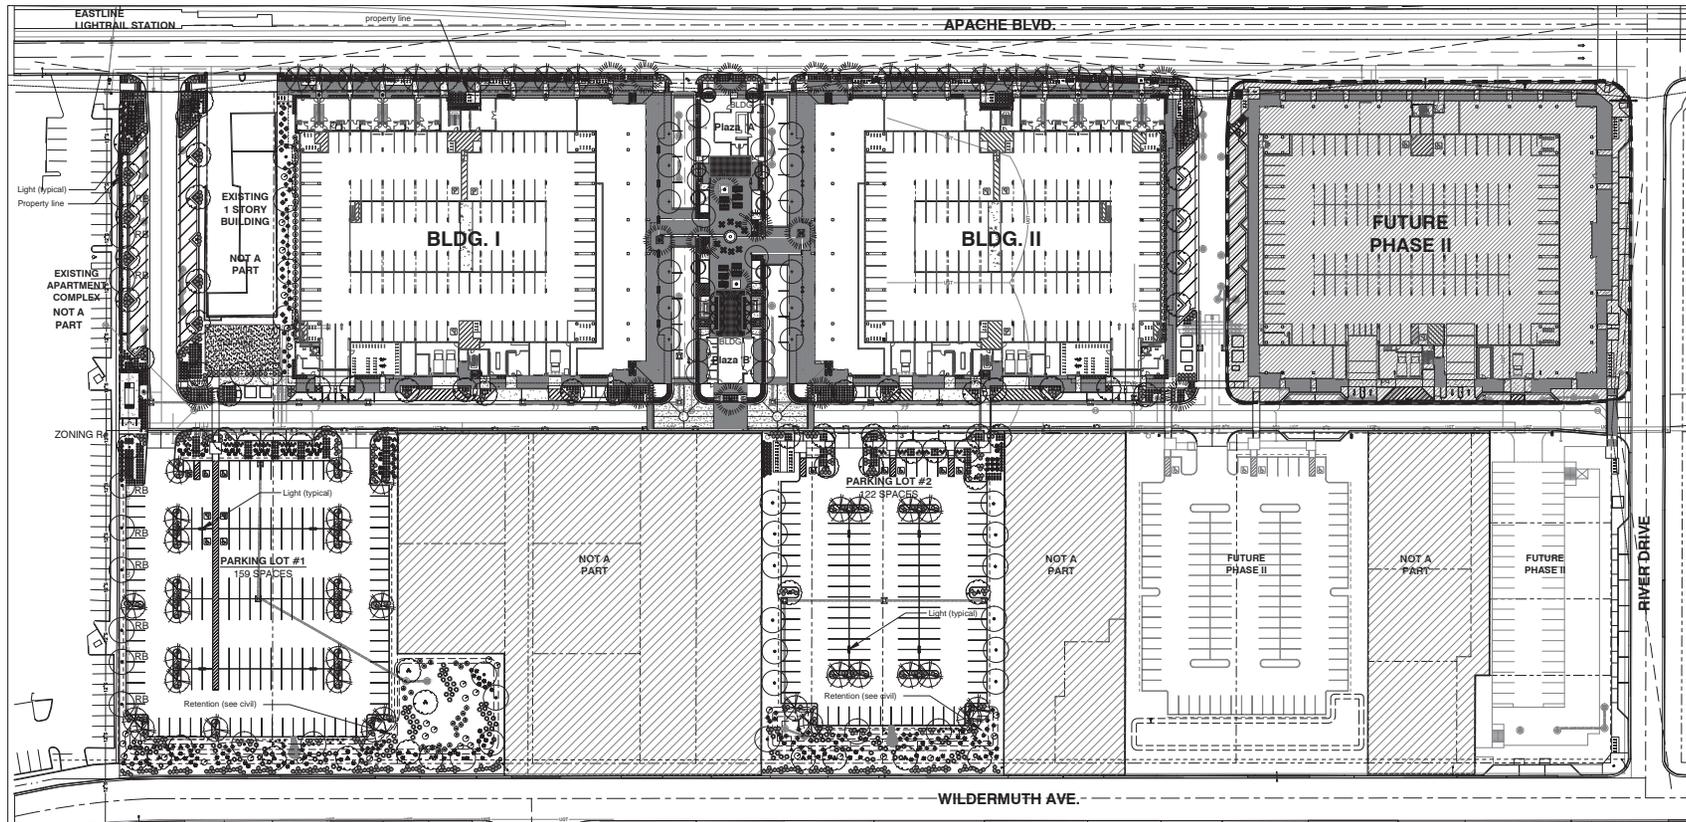


SHEET TITLE:
Open Space Plan

SHEET NUMBER:

A1.9

PAD / DPR #4



MASTER CONCEPTUAL LANDSCAPE PLAN - Ground Level

1" = 50'-0"

LANDSCAPE LEGEND

ALL TREES TO MEET OR EXCEED A.N.A. SPECIFICATIONS @ TIME OF PLANTING (ALL STREET TREES TO BE A MIN. OF 1.5" CALIPER)
 U.O.N. - Unless otherwise noted

TREES	SIZE	QTY	SHRUBS & VINES	SIZE
	60" Box	5 gallon		5 gallon
	Matching			5 gallon
	36" Box (unless noted otherwise)			5 gallon
	Standard, Matching			24" box
	24" Box			5 gallon
	36" Box			5 gallon
	48" Box			5 gallon
	Standard, Matching			(remove from stake, espalier)
	24" Box			5 gallon
	Standard, Matching			5 gallon
	24" Box			5 gallon
	Multi-trunk, Matching			5 gallon
	16" Trunk Feet			5 gallon
	Diamond Cut, Straight and Matching			5 gallon
				5 gallon
	36" Box			5 gallon
	Standard, Matching			5 gallon
				5 gallon

NOTE:

RB - Tree to receive Root Barrier per Detail on Sheet CL.03
 All trees within 16' of underground public water or sewer lines

SHRUBS & VINES	SIZE	GROUNDCOVER	SIZE
	5 gallon		5 gallon
	5 gallon		5 gallon
	5 gallon		5 gallon
	5 gallon		5 gallon
	5 gallon		5 gallon
	5 gallon		2" Depth, 1/2" select 'Express Brown'
	24" Box, matching, standard 8' Tall Min.		
	8' Min. height prior to planting		
	plant material 48" o.c. to create a continuous live screen wall.		

3/16" x 4" Steel Header (secure every 4')

CPTED NOTES:

All shrubs and groundcovers used in the following locations will not exceed 24" in height when mature.

Parking - Landscape Islands

Parking - Borders From 0' to 6'



Walks - From 0' to 6'

Entry - 15' Radius

Sight Triangles

All shrubs and groundcovers used in parking islands shall be a min. size of 5 gallon.

Per the City of Tempe Standards

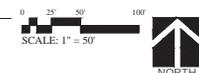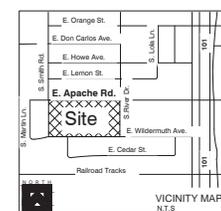

K & I HOMES, LLC
 4422 N. CIVIC CENTER PLAZA
 SUITE 200
 SCOTTSDALE, AZ 85251
 PH: 480-970-9800



VILLAGE
EASTLINE
 LIVE - WORK - PLAY
 APACHE BLVD. REDEVELOPMENT
 TEMPE, ARIZONA

Revisions		
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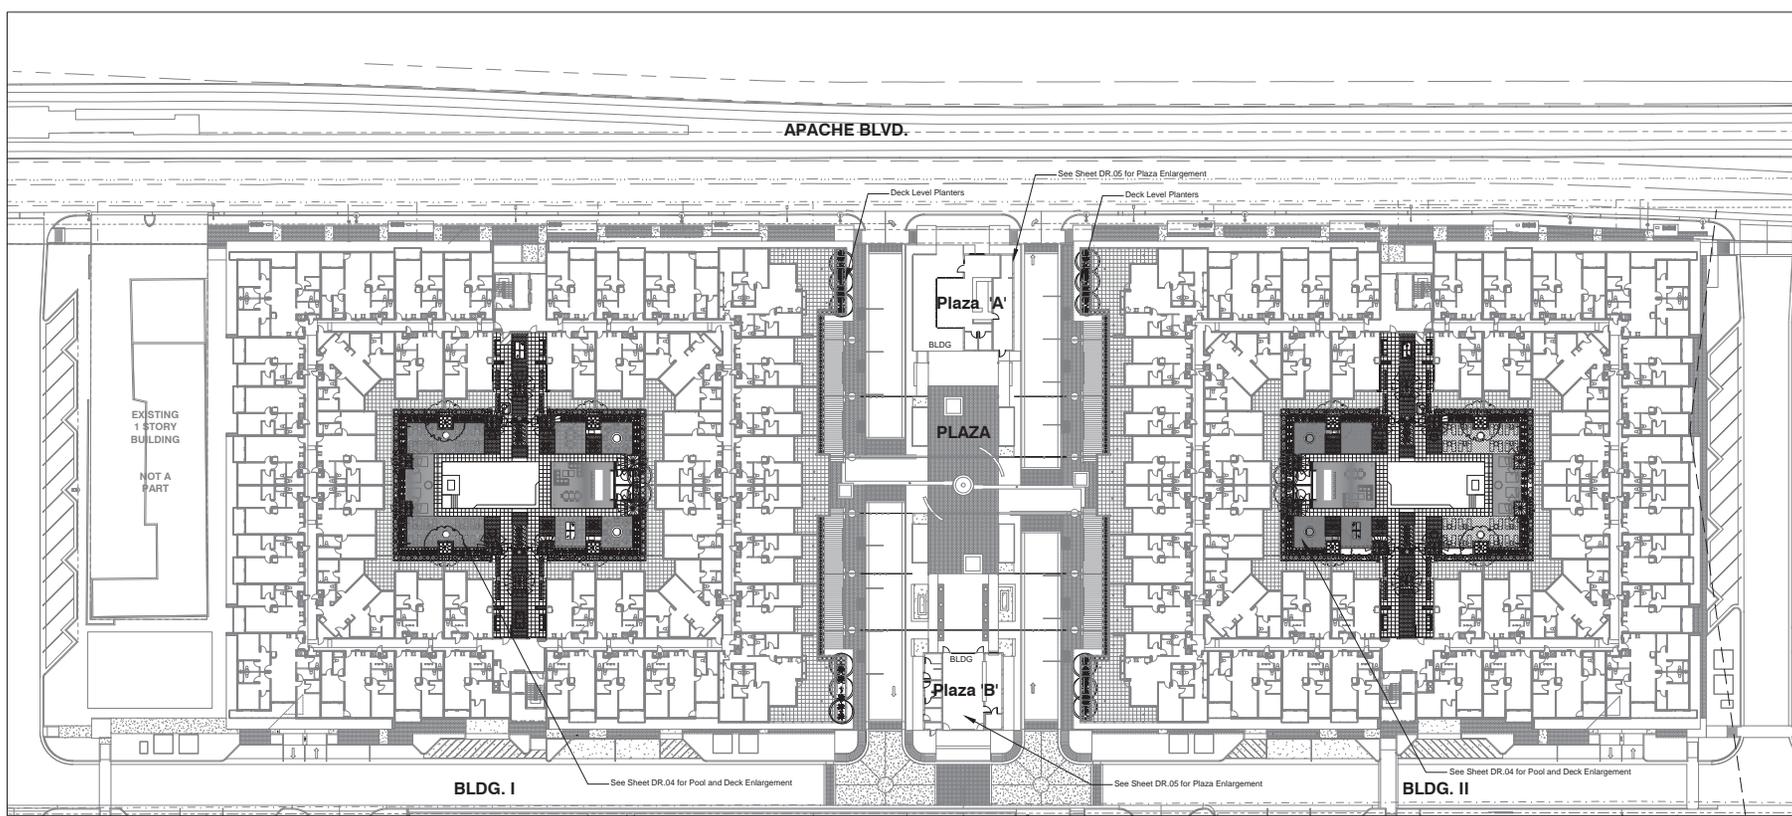
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 Conceptual Landscape Plan
 SHEET NUMBER:

CL.01
 of 6


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LASKIN & ASSOCIATES, INC.
 LANDSCAPE ARCHITECTS
 67 E. WILSON AVE.
 SUITE 200
 PHOENIX, ARIZONA 85012
 P (602) 448-7771
 F (602) 448-8121
 www.laskinpa.com





CONCEPTUAL LANDSCAPE PLAN - PHASE I - BLDG I & BLDG II - Deck Park Level
1" = 30'-0"

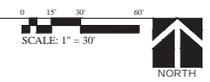


LANDSCAPE LEGEND

ALL TREES TO MEET OR EXCEED A.N.A. SPECIFICATIONS @ TIME OF PLANTING

TREE	SIZE	SHRUBS & VINES	SIZE
Quercus virginiana Heritage Live Oak	48" Box Standard, Matching	Dasylirion longissimum Mexican Grass Tree	5 Gallon
Phoenix dactylopera Date Palm	18" Trunk Feet Diamond Cut, Straight and Matching	Bougainvillea "Stained"	15 Gallon
Chamaecyparis humilis Mediterranean Fan Palm	36" box Multi-Trunk	Callistemon citrinus "Little John"	5 Gallon
		Euphorbia rigida Cyperus Plant	5 Gallon
		Ruellia brittoniana "Katie"	5 Gallon
		Hesperaloe parviflora Brake-light	15 Gallon
		Lantana montevidensis Gold Mound Lantana	5 Gallon
		Dodonaea viscosa Hopseed Bush	5 Gallon
		Aloe saponaria African Aloe	

OPTED NOTES:

All shrubs and groundcovers used in the following locations will not exceed 24" in height when mature.
 Parking - Landscape Islands
 Parking - Borders From 0' to 6'
 Walks - From 0' to 6'
 Entry - 15' Radius
 Sight Triangles
 All shrubs and groundcovers used in parking islands shall be a min. size of 5 gallon.
 Per the City of Tempe Standards

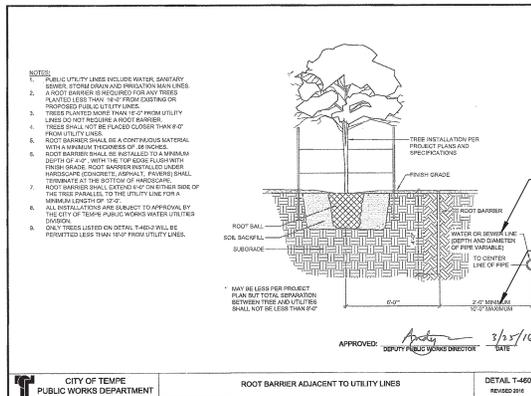

LASKIN & ASSOCIATES, INC.
 LANDSCAPE ARCHITECTS
 67 E. Wicken Ave.
 Suite 210
 Phoenix, Arizona 85012
 p (602) 448-7771
 f (602) 448-8121
 www.laskinlandscape.com

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K & I HOMES, LLC
 4422 N. GAVIN CENTER PLAZA
 SUITE 1000, AZ 85251
 PH: 480-970-8800



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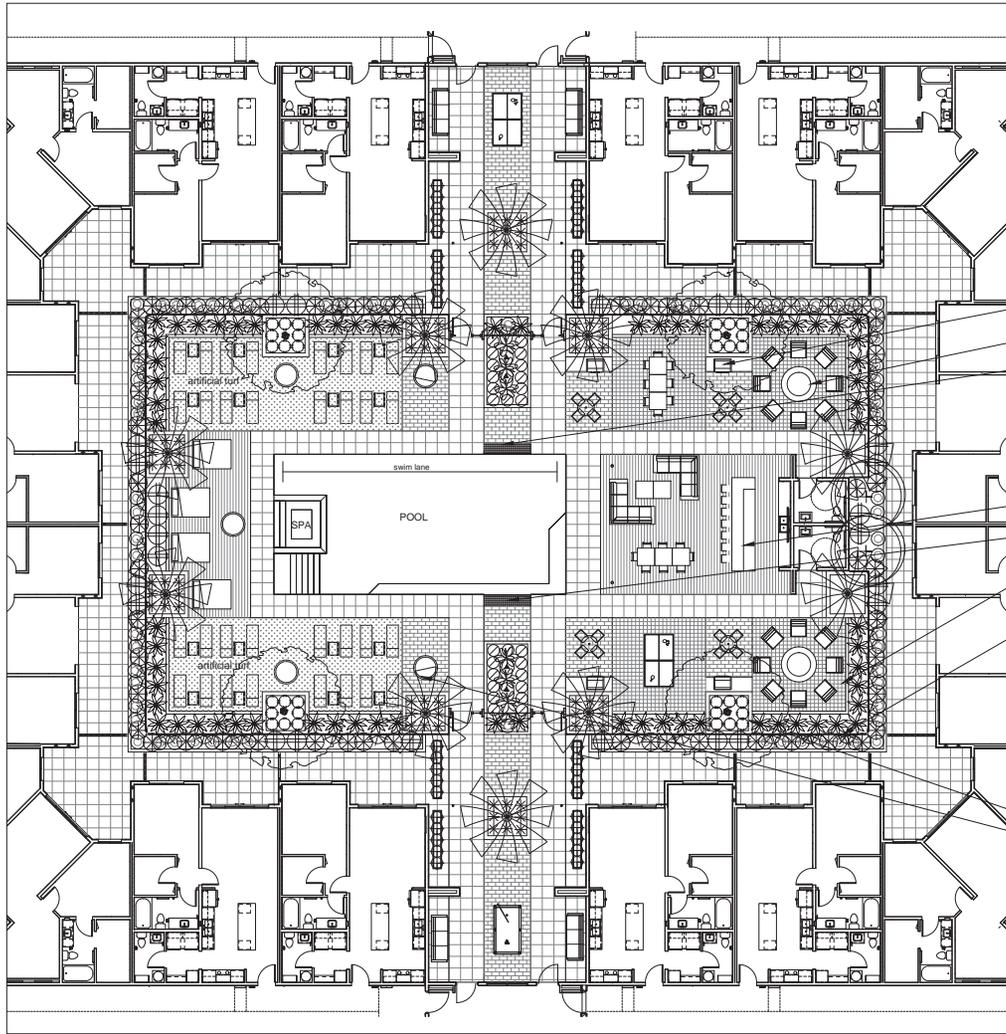


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 Conceptual Landscape Plan

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 CL.03

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- Gas BBQ and Counter Top
- Fire Pit and Seating Area
- Water Feature * Water Wall *
- Outdoor Bar and Seating Area
- Water Feature * Water Wall*
- Decorative Paving
- Decorative Metal Pool Fencing
- Raised Masonry Planter
- 42" Diameter Decorative Pots

CONCEPTUAL DECK PARK TYPICAL

1" = 10'-0"



LANDSCAPE LEGEND

ALL TREES TO MEET OR EXCEED A.N.A. SPECIFICATIONS @ TIME OF PLANTING

TREE	SIZE	SHRUBS & VINES	SIZE
Quercus virginiana Heritage Live Oak	48" Box Standard, Matching	Dasycten longispinum Mexican Grass Tree	5 Gallon
Phoenix dactylifera Date Palm	16" Trunk Feet Diamond Cut, Straight and Matching	Bougainvillea 'Barbara Karst'	15 Gallon
Chamaerops humilis Mediterranean Fan Palm	36" box Multi-Trunk	Callistemon citrinus 'Little John' Dwarf Bottlebrush	5 Gallon
		Euphorbia rigida Gopher Plant	5 Gallon
		Ruellia brittoniana 'Katie' Little Katie Ruellia	5 Gallon
		Hesperaloe parviflora Bristlelight	5 Gallon
		Lantana montevidensis Gold Mound Lantana	5 Gallon
		Dodonaea viscosa Hopseed Bush	5 Gallon
		Aloe saponaria African Aloe	5 Gallon



42" Diameter Decorative Fiberglass Pot
Color and Textures Available

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4422 N. CIVIC CENTER PLAZA
SCOTTSDALE, AZ 85251
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67 E. Wilshire Ave.
Suite 208
Phoenix, Arizona 85012
p (602) 848-7771
f (602) 848-8023
www.laskinlandscape.com



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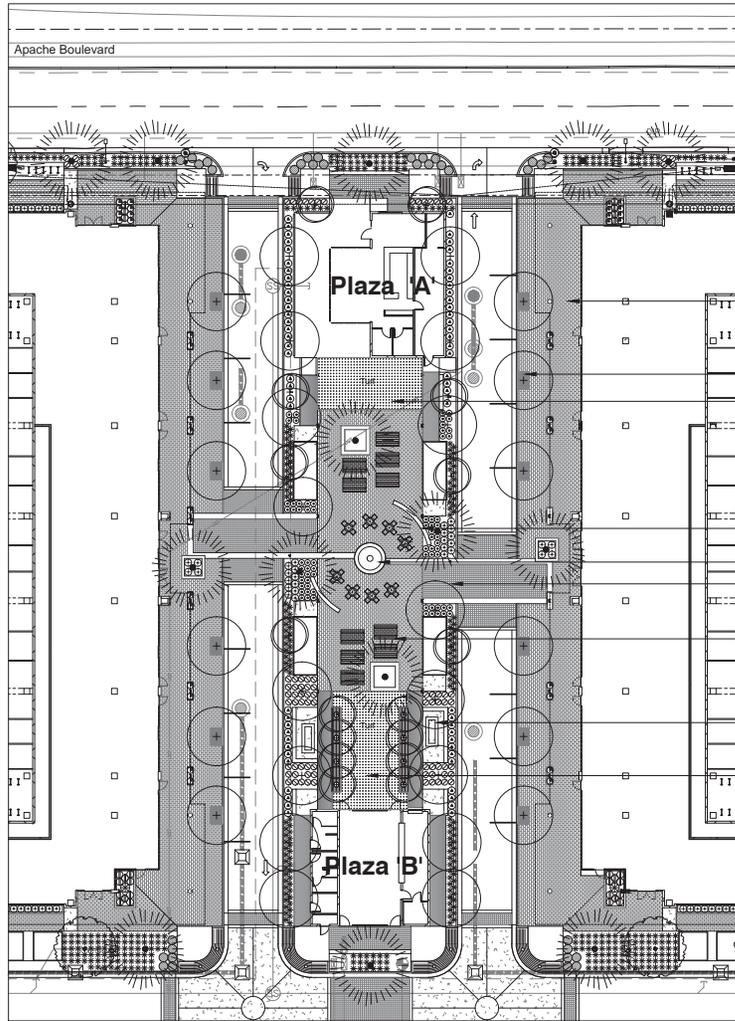
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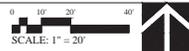
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CONCEPTUAL STREET LEVEL PLAZA ENLARGEMENT

1" = 20'-0"



LANDSCAPE LEGEND

ALL TREES TO MEET OR EXCEED A.N.A. SPECIFICATIONS @ TIME OF PLANTING
U.O.N. - Unless otherwise noted

TREES	SIZE	QTY
Pistache chinensis Chinese Pistache	60" Box Matching	
Ulmus parvifolia Evergreen Elm	36" Box U.O.N. Standard, Matching 24" Box	
Quercus virginiana Heritage Live Oak	36" Box Standard, Matching	
Fraxinus velutina 'Rio Grande' Fan - Tex Tree	48" Box Standard, Matching	
Eucalyptus papuana Ghost Gum	24" Box Standard, Matching	
Parkinsonia Hybrid Desert Museum Palo Verde	24" Box Multi-trunk, Matching	
Phoenix dactylifera Date Palm Pool Area Only	16" Trunk Feet Diamond Cut, Straight and Matching	
Nerium Oleander "Standard Red" Oleander Tree "Red"	36" Box Standard, Matching	

SHRUBS & VINES	SIZE
Pennisetum setaceum 'Rubrum' Purple Fountain Grass	5 gallon
Dasyliyon longispermum Mexican Grass Tree	5 gallon
Chamaerops humilis Mediterranean Fan Palm	24" box
Bougainvillea 'Barbara Kean' Bougainvillea 'staked' (remove from stake, espalier)	5 gallon
Aloe vera Medicinal Aloe	5 gallon
Yucca rupicola Twisted Yucca	5 gallon
Muhlenbergia Sp. Muhlenbergia Grass	5 gallon
Leucophyllum frutescens 'Compacta' Compact Texas Sage	5 gallon
Callisemon citrinus 'Little John' Dwarf Bottlebush	5 gallon
Nerium Oleander 'petite pink' Dwarf Pink Oleander	5 gallon
Euphorbia rigida Gopher Plant	5 gallon
Ruellia brittoniana 'Katie' Little Katie Ruellia	5 gallon
Aloe sp. Aloe	5 gallon
Podlanthus macrocarpus Lucy's Slipper	5 gallon
Caesophina mexicana Mexican Bird of Paradise	5 gallon
Agave geminiflora Twin Flower Agave	5 gallon

SHRUBS & VINES	SIZE
Hesperaloe funifera Giant Yucca	5 gallon
Hesperaloe parviflora Brakeslight	5 gallon
Hesperaloe parviflora 'Yellow Yucca' Yellow Yucca	5 gallon

GROUND COVER	SIZE
Lantana montevidensis Gold Mound Lantana	5 gallon
Lantana montevidensis Purple Trailing Lantana	5 gallon
Tradescantia pallida Purple Heart	5 gallon
Decomposed Granite - 2" Depth, 1/2" select 'Express Brown' In all non turf landscape areas	
Rip Rap - 3"-6" 'Express Brown' cobble to be used as erosion/ water control device, curb cuts, down spouts	
3/16" x 4" Steel Header (secure every 4')	

K & I HOMES, LLC
4422 N. CIVIC CENTER PLAZA
SCOTTSDALE, AZ 85251
PH: 480-970-8000



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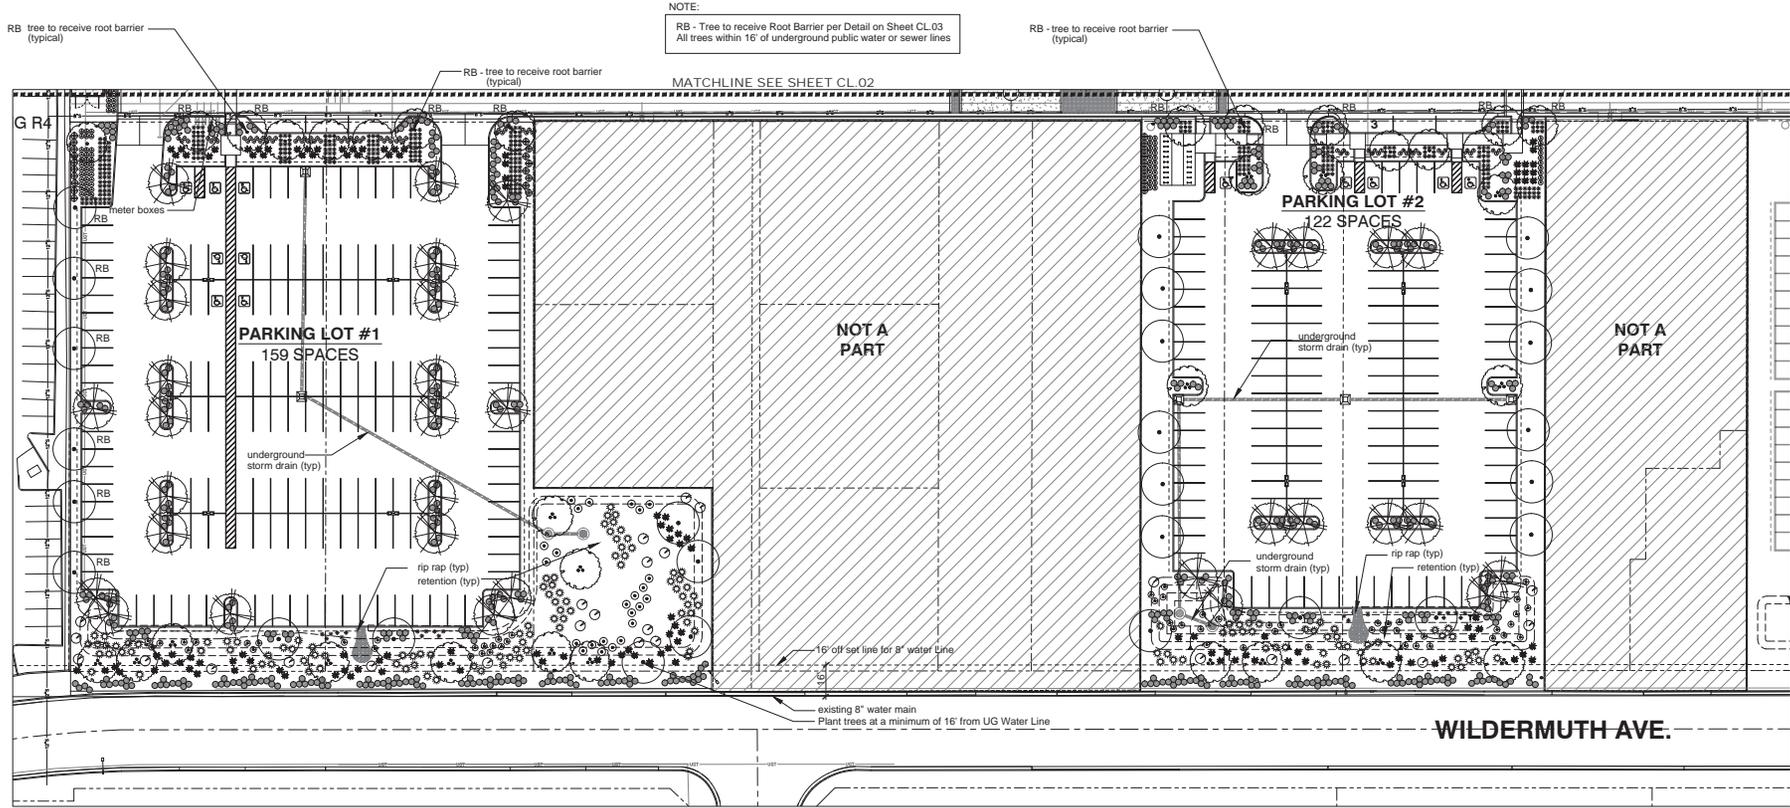
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LANDSCAPE ARCHITECTS
67 E. Wicken Ave.
Suite 200
Phoenix, Arizona 85012
P (602) 448-7771
F (602) 448-8023
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CONCEPTUAL LANDSCAPE PLAN - PHASE I - BLDG I & BLDG II - Ground - Level


1" = 30'-0"
LANDSCAPE LEGEND
ALL TREES TO MEET OR EXCEED A.N.A. SPECIFICATIONS @ TIME OF PLANTING (ALL STREET TREES TO BE A MIN. OF 1.5" CALIPER)
U.O.N. - Unless otherwise noted

TREES	SIZE	QTY	SHRUBS & VINES	SIZE
	Pistache chinensis Chinese Pistache	60' Box Matching	Pennisetum setaceum 'Rubrum' Purple Fountain Grass	5 gallon
	Ulmus parvifolia Evergreen Elm	36" Box (unless noted otherwise) Standard, Matching 24" Box	Daylilyon longicaelum Mexican Grass Tree	5 gallon
	Quercus virginiana Heritage Live Oak	36" Box Standard, Matching	Chamaerops humilis Medicanean Fan Palm	24" box
	Fraxinus velutina 'Rio Grande' Fan - Tex Tree	48" Box Standard, Matching	Bougainvillea 'Barbara Karst' Bougainvillea 'staked' (remove from stake, espalier)	5 gallon
	Eucalyptus papuana Ghost Gum	24" Box Standard, Matching	Aloe vera Medicinal Aloe	5 gallon
	Parkinsonia Hybrid Desert Museum Palo Verde	24" Box Multi-trunk, Matching	Yucca rupicola Twisted Yucca	5 gallon
	Phoenix dactylifera Date Palm Pool Area Only	16" Trunk Feet Diamond Cut, Straight and Matching	Muhlenbergia Sp. Muhlenbergia Grass	5 gallon
	Nerium Oleander "Standard Red" Oleander Tree "Red"	36" Box Standard, Matching	Leucophyllum frutescens "Compacta" Compact Texas Sage	5 gallon

SHRUBS & VINES	SIZE	SHRUBS & VINES	SIZE
	Hesperaloe funifera Purple Fountain Grass		Lantana montevidensis Gold Mound Lantana
	Hesperaloe parviflora Brakelight		Lantana Purple Lantana
	Hesperaloe parviflora 'Yellow Yucca' Yellow Yucca		Tradescantia pallida Purple Heart
	Ficus miltia 'Column' Indian Laurel Fig		Decomposed Granite - 2" Depth, 1/2" select 'Express Brown' In all non turf landscape areas

CPTD NOTES:
All shrubs and groundcovers used in the following locations will not exceed 24" in height when mature.
Parking - Landscape Islands
Parking - Borders From 0' to 6'
Walks - From 0' to 6'
Entry - 15 Radius
Sight Triangles

All shrubs and groundcovers used in parking islands shall be a min. size of 5 gallon.
Per the City of Tempe Standards

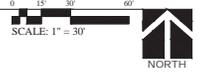

K & I HOMES, LLC
4422 N. GAVIN CENTER PLAZA
SCOTTSDALE, AZ 85251
PH: 480-970-8000



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LANDSCAPE ARCHITECTS
67 E. Wilkita Ave.
Suite 210
Phoenix, Arizona 85012
p (602) 848-7771
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MATERIAL / COLOR SCHEDULE

MATERIAL KEYNOTE:

COLOR:

MATERIALS / KEYNOTES

- EIFS SYSTEM OVER 1" EPS INSULATION BOARD - INTEGRAL COLOR TO MATCH PAINT COLOR SPECIFIED
- EIFS SYSTEM OVER 2" EPS INSULATION BOARD - INTEGRAL COLOR TO MATCH PAINT COLOR SPECIFIED
- CAST IN PLACE CONCRETE WALL - SMOOTH/NATURAL FINISH
- CAST IN PLACE CONCRETE COLUMN - SMOOTH/NATURAL FINISH
- CAST IN PLACE CONCRETE PLANTER - SMOOTH/NATURAL FINISH
- CAST IN PLACE BOARD FORMED CONCRETE PLANTER - NATURAL FINISH
- EXPOSED MASONRY - RUNNING BOND, RAKED JOINTS
- BALCONY FACIA - POWDERCOATED T-BAR AND EIFS TO MATCH PAINT COLOR SPECIFIED
- STEEL STEEL AND WIRE MESH (WIRECRAFTERS SPECIAL MESH 2" x 2' x 8 GA)
- RAILING/GUARDRAIL - PAINTED
- STEEL COLUMN - PAINTED
- CANTILEVERED STEEL FRAME CANOPY WITH PERFORATED MESH PANELS - PAINTED
- TUBE STEEL FRAME AND WIRE MESH (WIRECRAFTERS SPECIAL MESH 2" x 2' x 8 GA)
- SECURITY SCREEN - PAINTED
- VERTICAL STANDING SEAM WALL PANEL SYSTEM
- HORIZONTAL METAL WALL PANEL SYSTEM
- WOOD GRAIN ALUMINUM WALL SIDING SYSTEM
- FIBER CEMENT WALL PANEL SYSTEM
- T&G WOOD PANEL SIDING
- ALUMINUM STOREFRONT - FACTORY FINISH - SEE SCHEDULE
- ALUMINUM STOREFRONT DOORS - FACTORY FINISH - SEE SCHEDULE
- HOLLOW METAL DOOR AND FRAME - PAINTED - SEE SCHEDULE
- SLIDING ALUMINUM GLASS PATIO DOORS - FACTORY FINISH - SEE SCHEDULE
- FIXED SINGLE SLIDING ALUMINUM WINDOW - FACTORY FINISH - SEE SCHEDULE
- STANDING SEAM METAL ROOF
- 20W ALUM. TUBE TRUSS - POWDERCOATED
- STEEL COLUMN / CUSTOM LIGHT FIXTURE
- WALL MOUNTED LIGHT FIXTURE - SEE ELECTRICAL/PHOTOMETRICS
- STEEL POST AND GLASS GUARDRAIL
- SECTIONAL OR COILING GARAGE DOOR - FACTORY FINISH - SEE SCHEDULE
- EXHAUST FAN LOWERSCREEN - PAINTED
- BUILDING TENANT SIGNAGE - UNDER SEPARATE PERMIT AND SUBMITTAL
- TUBE STEEL GUARDRAIL WITH LAMINATED GLASS PANELS - COLORED FILM BETWEEN GLASS TO MATCH PAINT COLOR SPECIFIED
- CANTILEVERED PT CONCRETE SLAB BALCONY OR OVERHANG - PAINTED
- EDGE OF PT CONCRETE SLAB - PAINTED

COLORS

PAINT: DUNN EDWARDS DE / BENJAMIN MOORE BM / PITTSBURGH PAINTS PPG

A1: MAIN FIELD - BLDG. I (OFF WHITE) PPS 15-09 WHITE CHIP LRV 71

A2: MAIN FIELD - BLDG. II (LIGHT GRAY) BM OC-14 NATURAL CREAM LRV 65

A3: ACCENT - BLDG. I (DARK GRAY) DE 6384 IRON FIXTURE LRV 10

A4: ACCENT - BLDG. I (YELLOW) PPS 1209-6 BRASS MESH LRV 41

A5: ACCENT - BLDG. II (BLUE) DE 5768 MYSTERIOUS BLUE LRV 16

ALUMINUM WINDOWS, SLIDING GLASS DOORS AND STOREFRONT: (MILGARD / ARCADIA)

B1: MILGARD CLEAR ANODIZED

B2: ARCADIA AB-6 DARK BRONZE ANODIZED

MASONRY: (SUPERLITE BLOCK / TRENTWITH INDUSTRIES)

C1: BLDG. I 8X8X16 TRENDSSTONE GROUNDFACE - PEARL

C2: BLDG. II 8X8X16 TRENDSSTONE GROUNDFACE - RUTHERFORD

C3: BLDG. I&II 8X8X16 MESASTONE TEXTURED - BLACK MOUNTAIN

METAL PANEL SIDING:

D1: WOOD GRAIN SIDING - LONGBOARD - LIGHT NATIONAL WALNUT 1806/02-716

D2: FLAT STANDING SEAM - STEELSCOPE - VINTAGE

D3: HORIZONTAL ENGLERT (H-16-4) - PREWEATHERED GALVALUME

D4: STANDING SEAM ENGLERT - DARK BRONZE

FIBER CEMENT PANEL SYSTEM:

E1: CEMENT GRAPHITE 922

WOOD SIDING - 1/4" T&G RANDOM LENGTHS FROM 8" X:

G1: NOVAWOOD IRON/CLEAR


G2: H&W SAW TIMBER CO. CHARRED COLLECTION CYPRESS KUJAKU

G3: H&W SAW TIMBER CO. CHARRED COLLECTION CYPRESS HOWATO

GENERAL NOTES

- EIFS SYSTEM TO BE SENERGY SENERFLEX CHANNELLED ADHESIVE DESIGN OVER 1" OR 2" INSULATION BOARD, WITH TEXTURE INTEGRAL COLORED FINISH TO MATCH PAINT COLOR SPECIFIED. SYSTEM TO BE INSTALLED OVER WATER RESISTIVE BARRIER COATING, PER THE FOLLOWING EVALUATION REPORTS: ESR-1078 SENERGY SENERFLEX CHANNELLED ADHESIVE DESIGN OR APPROVED EQUAL
- ALL CONTROL JOINTS & REVEALS TO TERMINATE ON INSIDE CORNERS ONLY. VERIFY LOCATION WITH ARCHITECT.
- PROVIDE SEALANT AT ALL EIFS PENETRATIONS.
- PAINT ALL EXTERIOR MOUNTED ELECTRICAL AND MECHANICAL PANELS/BOXES TO MATCH ADJACENT SURFACE OF THE BUILDING.
- PAINT ALL VENTS, FLASHING ETC. TO MATCH ADJ. BUILDING COLOR. U.N.O.
- ALL EIFS COLOR CHANGES TO TERMINATE ON INSIDE CORNERS ONLY.
- ALL EXPOSED CMU TO BE WATERSEALED.
- ALL EXPOSED DRYER AND EXHAUST VENTS TO BE ALIGNED HORIZONTALLY (AT EACH FLOOR), AND VERTICALLY (FROM FLOOR TO FLOOR) AND PAINTED TO MATCH ADJACENT EIFS COLOR.
- RESIDENTIAL WINDOWS TO HAVE DUAL INSULATED GLAZING WITH SUNCOAT LOW-E MIN. U-FACTOR: 0.31 (SLIDING DOORS); .40 OPERABLE WINDOWS; .40 FIXED WINDOWS MIN. SHGC: .25
- STOREFRONT GLAZING TO BE 1" DUAL INSULATED CLEAR GLAZING MIN. U-FACTOR: 0.47 MIN. SHGC: 0.28

KEYPLAN

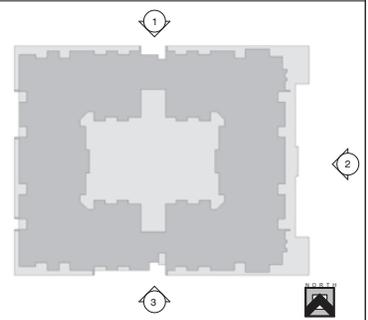

K & I HOMES, LLC
 4422 N. DAVIS CENTER PLAZA
 SUITE 202
 SCOTTSDALE, AZ 85251
 PH: 480-970-8800



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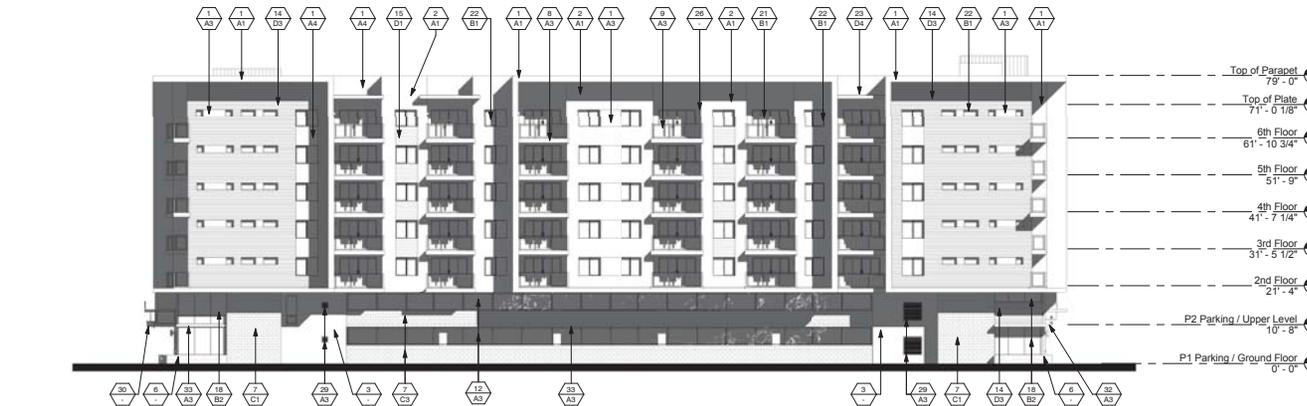
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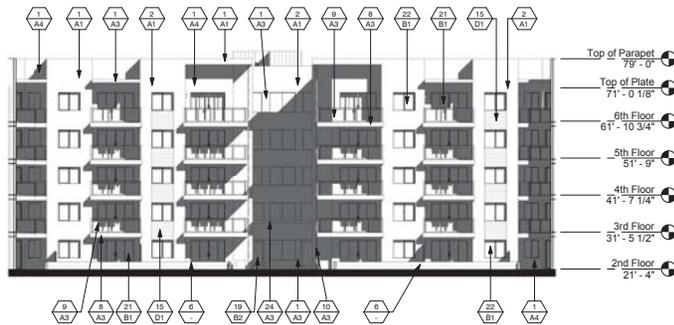
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Bldg 1 - Building Elevations

SHEET NUMBER:
A2.10


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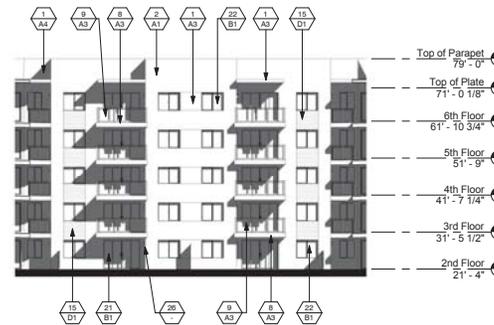
1 Bldg I - West Elevation
1/16" = 1'-0"




2 Bldg I - South Courtyard Elevation
1/16" = 1'-0"



4 Bldg I - North Courtyard Elevation
1/16" = 1'-0"

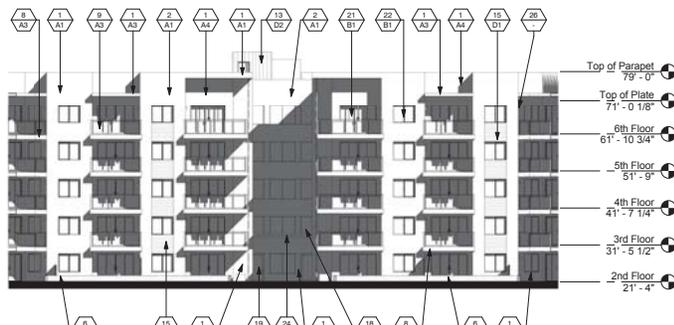

3 Bldg I - West Courtyard Elevation
1/16" = 1'-0"

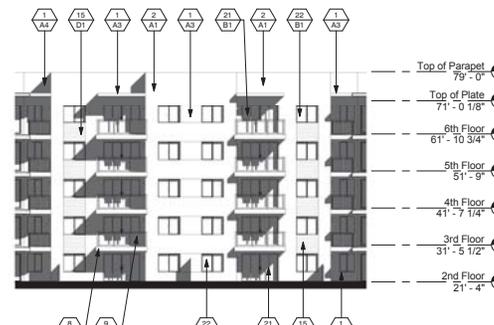

5 Bldg I - East Courtyard Elevation
1/16" = 1'-0"

MATERIAL / COLOR SCHEDULE

MATERIAL / KEYNOTE - X
COLORS -

MATERIALS / KEYNOTES


1. EPS SYSTEM OVER 1" EPS INSULATION BOARD - INTEGRAL COLOR TO MATCH PAINT COLOR SPECIFIED
2. EPS SYSTEM OVER 2" EPS INSULATION BOARD - INTEGRAL COLOR TO MATCH PAINT COLOR SPECIFIED
3. CAST IN PLACE CONCRETE WALL - SMOOTH/NATURAL FINISH
4. CAST IN PLACE CONCRETE COLUMN - SMOOTH/NATURAL FINISH
5. CAST IN PLACE CONCRETE PLANTER - SMOOTH/NATURAL FINISH
6. CAST IN PLACE BOARD FORMED CONCRETE PLANTER - NATURAL FINISH
7. EXPOSED MASONRY - RUNNING BOND, RAKED JOINTS
8. BALCONY FACIA - POWDERCOATED T-BAR AND EPS TO MATCH PAINT COLOR SPECIFIED
9. TUBE STEEL AND WIRE MESH W/RECRRAFTERS SPECIAL MESH 2" x 2" x 8 GA)
10. RAILING/GUARDRAIL - PAINTED
11. STEEL COLUMN - PAINTED
12. CANTILEVERED STEEL FRAME CANOPY WITH PERFORATED MESH PANELS - PAINTED
13. TUBE STEEL FRAME AND WIRE MESH (W/RECRRAFTERS SPECIAL MESH 2" x 2" x 8 GA)
14. SECURITY SCREEN - PAINTED
15. VERTICAL STANDING SEAM WALL PANEL SYSTEM
16. HORIZONTAL METAL WALL PANEL SYSTEM
17. WOOD GRAIN ALUMINUM WALL SIDING PANEL SYSTEM
18. FIBER CEMENT WALL PANEL SYSTEM
19. T&G WOOD PANEL SIDING
20. ALUMINUM STOREFRONT - FACTORY FINISH
21. ALUMINUM STOREFRONT DOORS - FACTORY FINISH - SEE SCHEDULE
22. HOLLOW METAL DOOR AND FRAME - PAINTED - SEE SCHEDULE
23. SLIDING ALUMINUM GLASS PATIO DOORS - FACTORY FINISH - SEE SCHEDULE
24. FREE SINGLE SLIDING ALUMINUM WINDOW - FACTORY FINISH - SEE SCHEDULE
25. STANDING SEAM METAL ROOF
26. 2X6 ALUM. TUBE TRUSS - POWDERCOATED
27. STEEL COLUMN / CUSTOM LIGHT FIXTURE
28. WALL MOUNTED LIGHT FIXTURE - SEE ELECTRICAL/PHOTOMETRICS
29. STEEL POST AND GLASS GUARDRAIL
30. SECTIONAL OR COILING GARAGE DOOR - FACTORY FINISH - SEE SCHEDULE
31. EXHAUST FAN LOWERSCREEN - PAINTED
32. BUILDING TENANT SIGNAGE - UNDER SEPARATE PERMIT AND SUBMITTAL
33. TUBE STEEL GUARDRAIL WITH LAMINATED GLASS PANELS - COLORED FILM BETWEEN GLASS TO MATCH PAINT COLOR SPECIFIED
34. CANTILEVERED PT CONCRETE SLAB BALCONY OR OVERHANG - PAINTED
35. EDGE OF PT CONCRETE SLAB - PAINTED

COLORS

- PANEL:** DUNN EDWARDS DE / BENJAMIN MOORE BM / PITTSBURGH PAINTS PPG)
- A1: MAIN FIELD - BLDG. I (OFF WHITE) PPS 15-08 WHITE CHIP - LRV 71
 - A2: MAIN FIELD - BLDG. II (LIGHT GRAY) BM OC-14 NATURAL CREAM - LRV 65
 - A3: ACCENT - BLDG. I (DARK GRAY) DE 8384 IRON FIXTURE - LRV 10
 - A4: ACCENT - BLDG. I (YELLOW) PPS 1209-6 BRASS MESH - LRV 41
 - A5: ACCENT - BLDG. II (BLUE) DE 5768 MYSTERIOUS BLUE - LRV 16
- ALUMINUM WINDOWS, SLIDING GLASS DOORS AND STOREFRONT: (MILGARD / ARCADIA)**
- B1: MILGARD "CLEAR" ANODIZED
 - B2: ARCADIA AB-6 "DARK BRONZE" ANODIZED
- MASONRY: (SUPERLITE BLOCK / TRENTWIN INDUSTRIES)**
- C1: BLDG. I 8X8X16 TRENSTONE GROUNDFACE - PEARL
 - C2: BLDG. II 8X8X16 TRENSTONE GROUNDFACE - RUTHERFORD
 - C3: BLDG. III 8X8X16 MESASTONE TEXTURED - BLACK MOUNTAIN
- METAL PANEL SIDING:**
- D1: WOOD GRAIN SIDING - LONGBOARD - LIGHT NATIONAL WALNUT 1806/02-716
 - D2: FLAT STANDING SEAM - STEEL SCOPE - VINYLACE
 - D3: HORIZONTAL - ENGLERT (H-16-4) - PREWEATHERED GALVALUME
 - D4: STANDING SEAM - ENGLERT - DARK BRONZE
- FIBER CEMENT PANEL (CEMENT)**
- E1: CEMENT GUARANTEED 922
- WOOD SIDING - 1/2" T&G RANDOM LENGTHS FROM 3/4"**
- G1: NOWWOOD IROKOCLEAR
 - G2: H&WAIN TIMBER CO. CHARRED COLLECTION CYPRESS KUJAKU
 - G3: H&WAIN TIMBER CO. CHARRED COLLECTION CYPRESS HOWARTO

- GENERAL NOTES**
1. EPS SYSTEM TO BE SENERGY SENERFLEX CHANNELLED ADHESIVE DESIGN OVER 1" OR 2" INSULATION BOARD WITH FINE TEXTURE INTEGRAL COLORED FINISH TO MATCH PAINT COLOR. SPECIFIED SYSTEM TO BE INSTALLED OVER WATER RESISTIVE BARRIER COATING. PER THE FOLLOWING EVALUATION REPORTS:
ESR-1878 SENERGY SENERFLEX CHANNELLED ADHESIVE DESIGN OR APPROVED EQUAL
 2. ALL CONTROL JOINTS & REVEALS TO TERMINATE ON INSIDE CORNERS ONLY. VERIFY LOCATION WITH ARCHITECT.
 3. PROVIDE SEALANT AT ALL EPS PENETRATIONS.
 4. PAINT ALL EXTERIOR MOUNTED ELECTRICAL AND MECHANICAL PANELS/BOXES TO MATCH ADJACENT SURFACE OF THE BUILDING.
 5. PAINT ALL VENTS, FLASHING, ETC. TO MATCH ADJ. BUILDING COLOR. U.N.O.
 6. ALL EPS COLOR CHANGES TO TERMINATE ON INSIDE CORNERS ONLY.
 7. ALL EXPOSED CMU TO BE WATERSEALED
 8. ALL EXPOSED DRYER AND EXHAUST VENTS TO BE ALIGNED HORIZONTALLY (AT EACH FLOOR), AND VERTICALLY (FROM FLOOR TO FLOOR) AND PAINTED TO MATCH ADJACENT EPS COLOR
 9. RESIDENTIAL WINDOWS TO HAVE DUAL INSULATED GLAZING WITH SUNCOAT LOW-E MIN. U-FACTOR: 0.31 (SLIDING DOORS); .49 (OPERABLE WINDOWS); .49 FIXED WINDOWS MIN. SHGC: .25
 10. STOREFRONT GLAZING TO BE 1" DUAL INSULATED CLEAR GLAZING MIN. U-FACTOR: 0.47 MIN. SHGC: 0.28

KEYPLAN

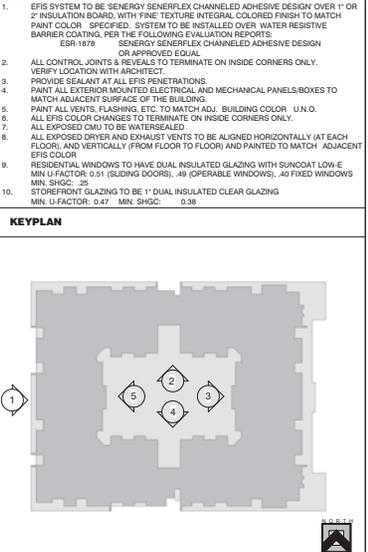

K & J HOMES, LLC
4422 N. DAVIS CENTER PLAZA
SUITE 202
SCOTTSDALE, AZ 85251
PH: 480-970-8800



uhhc
URBAN HOME
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DMB

VILLAGE
EASTLINE
LIVE - WORK - PLAY
APACHE BLVD. REDEVELOPMENT
TEMPE, ARIZONA

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JOB NUMBER:
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CHECKED BY: KS
ISSUE DATE: 06/22/2016

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K. Sourdis

SHEET TITLE:
Bldg I -
Building Elevations
SHEET NUMBER:

A2.11

PAD / DPR #3



MATERIAL / COLOR SCHEDULE

MATERIAL / KEYNOTE

COLOR

MATERIALS / KEYNOTES

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- ALUMINUM STOREFRONT DOORS - FACTORY FINISH - SEE SCHEDULE
- HOLLOW METAL DOOR AND FRAME - PAINTED - SEE SCHEDULE
- SLIDING ALUMINUM GLASS PATIO DOORS - FACTORY FINISH - SEE SCHEDULE
- FIXED SINGLE SLIDING ALUMINUM WINDOW - FACTORY FINISH - SEE SCHEDULE
- STANDING SEAM METAL ROOF
- 200 ALUM. TUBE TRIBLE LIGHTS - POWDERCOATED
- STEEL COLUMN / CUSTOM LIGHT FIXTURE
- WALL MOUNTED LIGHT FIXTURE - SEE ELECTRICAL/PHOTOMETRICS
- STEEL POST AND GLASS GUARDRAIL
- SECTIONAL OR COILING GARAGE DOOR - FACTORY FINISH - SEE SCHEDULE
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PAINT: DUNN EDWARDS DE / BENJAMIN MOORE BM/ PITTSBURGH PAINTS PPG)

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A4: ACCENT - BLDG. I (YELLOW) PPS 1209-6 BRASS MESH LRV 41

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ALUMINUM WINDOWS, SLIDING GLASS DOORS AND STOREFRONT: (MILGARD / ARCADIA)

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C2: BLDG. II 8X8X16 TRENTHSTONE GROUNDFACE - RUTHERFORD

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METAL PANEL SIDING:

D1: WOOD GRAIN SIDING - LONGBOARD - LIGHT NATIONAL WALNUT 1806/02-716

D2: FLAT STANDING SEAM - STEELSCAPE - VINTAGE

D3: HORIZONTAL ENGLERT (H-16-4) - PREWEATHERED GALVALUME

D4: STANDING SEAM ENGLERT - DARK BRONZE

FIBER CEMENT PANEL SYSTEM:

E1: CEMENT GUARDITE 922

WOOD SIDING - 1/4" T&G RANDOM LENGTHS FROM 8'-0"

G1: NOWWOOD IROKOCLEAR


G2: H&SAVIN TIMBER CO. CHARRED COLLECTION CYPRESS-KUJAKU

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GENERAL NOTES

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SUITE 202
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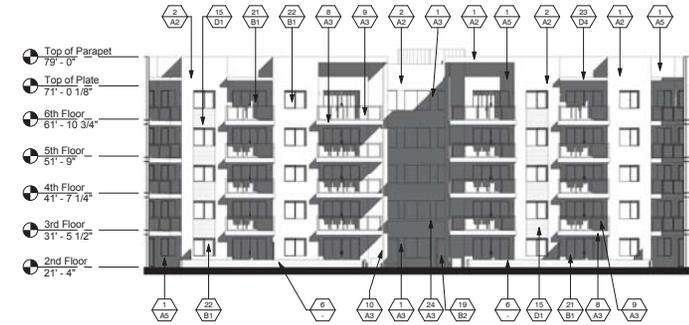


SHEET TITLE:
Bldg II - Building Elevations
SHEET NUMBER:
A3.10


PAD / DPR #3

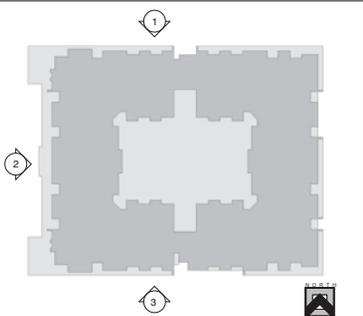


1 Bldg I - East Elevation
1/16" = 1'-0"




2 Bldg I - South Courtyard Elevation
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MATERIAL / COLOR SCHEDULE

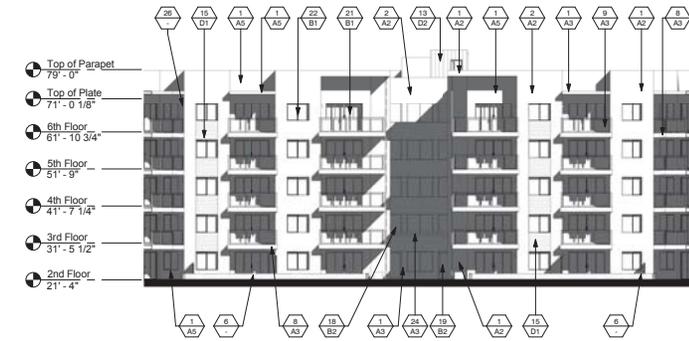MATERIAL / KEYNOTE
COLOR -

MATERIALS / KEYNOTES
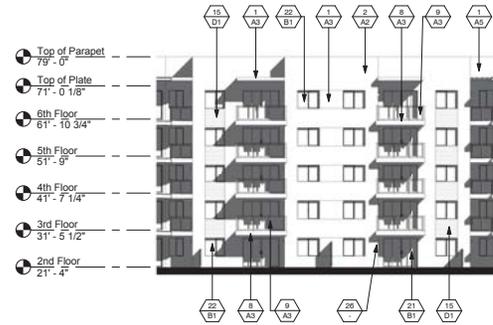
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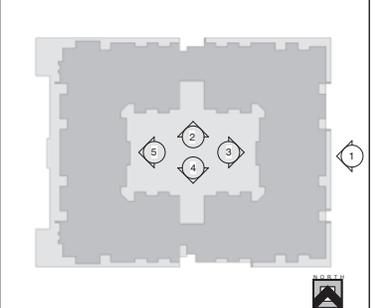
- FIBER CEMENT PANEL (CEMENT)
- E1. CEMENT GRAPITE 922

- WOOD SIDING - 1/2" T&G RANDOM LENGTHS FROM 8'-0"
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SHEET TITLE:
Bldg II -
Building Elevations
SHEET NUMBER:

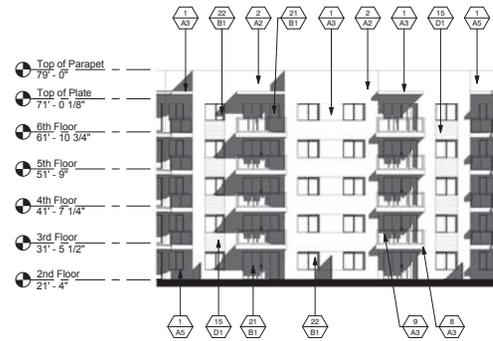A3.11

PAD / DPR #3



1 Bldg I - North Elevation
1/16" = 1'-0"



2 Bldg I - East Elevation
1/16" = 1'-0"



3 Bldg I - South Elevation
1/16" = 1'-0"

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MATERIAL / KEYNOTE	
COLOR	
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19.	ALUMINUM STOREFRONT - FACTORY FINISH - SEE SCHEDULE
20.	HOLLOW METAL DOOR AND FRAME - PAINTED - SEE SCHEDULE
21.	SLIDING ALUMINUM GLASS PATIO DOORS - FACTORY FINISH - SEE SCHEDULE
22.	TRENDSINGLE SLIDING ALUMINUM WINDOW - FACTORY FINISH - SEE SCHEDULE
23.	STANDING SEAM METAL ROOF
24.	20W ALUM. TUBE TRUSS - POWDERCOATED
25.	STEEL COLUMN / CUSTOM LIGHT FIXTURE
26.	WALL MOUNTED LIGHT FIXTURE - SEE ELECTRICAL/PHOTOMETRICS
27.	STEEL POST AND GLASS GUARDRAIL
28.	SECTIONAL OR COILING GARAGE DOOR - FACTORY FINISH - SEE SCHEDULE
29.	EXHAUST FAN LOWERSCREEN - PAINTED
30.	BUILDING/TENANT SIGNAGE - UNDER SEPARATE PERMIT AND SUBMITTAL
31.	TUBE STEEL GUARDRAIL WITH LAMINATED GLASS PANELS - COLORED FILM BETWEEN GLASS TO MATCH PAINT COLOR SPECIFIED
32.	CANTILEVERED PT CONCRETE SLAB BALCONY OR OVERHANG - PAINTED
33.	EDGE OF PT CONCRETE SLAB - PAINTED


COLORS

PAINT:	DUNN EDWARDS® DE / BENJAMIN MOORE® BM / PITTSBURGH PAINTS PPG)
A1:	MAIN FIELD - BLDG. I (OFF WHITE) PPS 15-09 WHITE CHIP
A2:	MAIN FIELD - BLDG. II (LIGHT GRAY) BM OC-14 NATURAL CREAM
A3:	ACCENT - BLDG. I (DARK GRAY) DE 6384 IRON FIXTURE
A4:	ACCENT - BLDG. I (YELLOW) PPS 1209-6 BRASS MESH
A5:	ACCENT - BLDG. II (BLUE) DE 5768 MYSTERIOUS BLUE
A6:	ACCENT - BLDG. II (BLUE) DE 5768 MYSTERIOUS BLUE
ALUMINUM WINDOWS, SLIDING GLASS DOORS AND STOREFRONT: (MILGARD / ARCADIA)	
B1:	MILGARD CLEAR ANODIZED
B2:	ARCADIA AB-6 DARK BRONZE ANODIZED
MASONRY: (SUPERLITE BLOCK / TRENTON WITH INDUSTRIES)	
C1:	BLDG. I 8X8X16 TRENDSINGLE GROUNDFACE - PEARL
C2:	BLDG. II 8X8X16 TRENDSINGLE GROUNDFACE - RUTHERFORD
C3:	BLDG. I&II 8X8X16 MESASTONE TEXTURED - BLACK MOUNTAIN
METAL PANEL SIDING:	
D1:	WOOD GRAIN SIDING - LONGBOARD - LIGHT NATIONAL WALNUT 1806/02-716
D2:	FLAT STANDING SEAM - STEELSCOPE - VINTAGE
D3:	HORIZONTAL ENGLERT (H-16-4) - PREWEATHERED GALVALUME
D4:	STANDING SEAM ENGLERT - DARK BRONZE
FIBER CEMENT PANEL (CEMENT)	
E1:	CEMENT GRAPITE 922
WOOD SIDING - 1/2" T&G RANDOM LENGTHS FROM 8" TO:	
G1:	NOVAWOOD IRON/CLEAR
G2:	MSAWN TIMBER CO. CHARRED COLLECTION CYPRESS-KUJAKU
G3:	MSAWN TIMBER CO. CHARRED COLLECTION CYPRESS-HOWATO

GENERAL NOTES

- EIFS SYSTEM TO BE SENERGY SENERIFLEX CHANNELLED ADHESIVE DESIGN OVER 1" OR 2" INSULATION BOARD, WITH TEXTURE INTEGRAL COLORED FINISH TO MATCH PAINT COLOR SPECIFIED. SYSTEM TO BE INSTALLED OVER WATER RESISTIVE BARRIER COATING, PER THE FOLLOWING EVALUATION REPORTS:
SER-1878 SENERGY SENERIFLEX CHANNELLED ADHESIVE DESIGN OR APPROVED EQUAL
- ALL CONTROL JOINTS & REVEALS TO TERMINATE ON INSIDE CORNERS ONLY. VERIFY LOCATION WITH ARCHITECT.
- PROVIDE SEALANT AT ALL EIFS PENETRATIONS.
- PAINT ALL EXTERIOR MOUNTED ELECTRICAL AND MECHANICAL PANELS/BOXES TO MATCH ADJACENT SURFACE OF THE BUILDING.
- PAINT ALL VENTS, FLASHING, ETC. TO MATCH ADJ. BUILDING COLOR. U.N.O.
- ALL EIFS COLOR CHANGES TO TERMINATE ON INSIDE CORNERS ONLY.
- ALL EXPOSED CMU TO BE WATERSEALED
- ALL EXPOSED DRYER AND EXHAUST VENTS TO BE ALIGNED HORIZONTALLY (AT EACH FLOOR), AND VERTICALLY (FROM FLOOR TO FLOOR) AND PAINTED TO MATCH ADJACENT EIFS COLOR
- RESIDENTIAL WINDOWS TO HAVE DUAL INSULATED GLAZING WITH SUNCOAT LOW-E MIN. U-FACTOR: 0.31 (SLIDING DOORS); .40 OPERABLE WINDOWS; .40 FIXED WINDOWS MIN. SHGC: .25
- STOREFRONT GLAZING TO BE 1" DUAL INSULATED CLEAR GLAZING MIN. U-FACTOR: 0.47 MIN. SHGC: 0.28

KEYPLAN

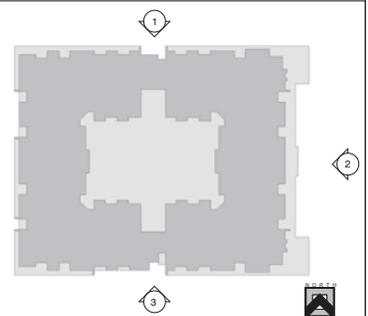

K & I HOMES, LLC
4422 N. DAVIS CENTER PLAZA
SUITE 202
SCOTTSDALE, AZ 85251
PH: 480-970-8800



VILLAGE EASTLINE
LIVE - WORK - PLAY
APACHE BLVD. REDEVELOPMENT
TEMPE, ARIZONA

Revisions

#	Description	Date

OWNERSHIP OF DOCUMENTS
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JOB NUMBER:
DRAWN BY: AD
CHECKED BY: KS
ISSUE DATE: 06/22/2016

SHEET TITLE:
Bldg I -
Building Elevations
SHEET NUMBER:
A2.10

PAD / DPR #3



1 Bldg I - West Elevation
1/16" = 1'-0"



2 Bldg I - South Courtyard Elevation
1/16" = 1'-0"



4 Bldg I - North Courtyard Elevation
1/16" = 1'-0"



3 Bldg I - West Courtyard Elevation
1/16" = 1'-0"



5 Bldg I - East Courtyard Elevation
1/16" = 1'-0"

MATERIAL / COLOR SCHEDULE

MATERIAL / KEYNOTE - COLOR -

MATERIALS / KEYNOTES

- EIFS SYSTEM OVER 1" EPS INSULATION BOARD - INTEGRAL COLOR TO MATCH PAINT COLOR SPECIFIED
- EIFS SYSTEM OVER 2" EPS INSULATION BOARD - INTEGRAL COLOR TO MATCH PAINT COLOR SPECIFIED
- CAST IN PLACE CONCRETE WALL - SMOOTH/NATURAL FINISH
- CAST IN PLACE CONCRETE COLUMN - SMOOTH/NATURAL FINISH
- CAST IN PLACE CONCRETE PLANTER - SMOOTH/NATURAL FINISH
- CAST IN PLACE BOARD FORMED CONCRETE PLANTER - NATURAL FINISH
- EXPOSED MASONRY - RUNNING BOND, RAKED JOINTS
- BALCONY FACIA - POWDERCOATED T-BAR AND EIFS TO MATCH PAINT COLOR SPECIFIED
- TUBE STEEL AND WIRE MESH (WIRECRAFTERS SPECIAL MESH 2" x 2" x 8 GA) RAILING/GUARDRAIL - PAINTED
- STEEL COLUMN - PAINTED
- CANTILEVERED STEEL FRAME CANOPY WITH PERFORATED MESH PANELS - PAINTED
- TUBE STEEL FRAME AND WIRE MESH (WIRECRAFTERS SPECIAL MESH 2" x 2" x 8 GA) SECURITY SCREEN - PAINTED
- VERTICAL STANDING SEAM WALL PANEL SYSTEM
- HORIZONTAL METAL WALL PANEL SYSTEM
- WOOD GRAIN ALUMINUM WALL SIDING PANEL SYSTEM
- FIBER CEMENT WALL PANEL SYSTEM
- T&G WOOD PANEL SIDING
- ALUMINUM STOREFRONT - FACTORY FINISH
- ALUMINUM STOREFRONT DOORS - FACTORY FINISH - SEE SCHEDULE
- HOLLOW METAL DOOR AND FRAME - SEE SCHEDULE
- SLIDING ALUMINUM GLASS PATIO DOORS - FACTORY FINISH - SEE SCHEDULE
- FIXED SINGLE SLIDING ALUMINUM WINDOW - FACTORY FINISH - SEE SCHEDULE
- STANDING SEAM METAL ROOF
- 20W ALUM. TUBE TRUSS - POWDERCOATED
- STEEL COLUMN / CUSTOM LIGHT FIXTURE
- WALL MOUNTED LIGHT FIXTURE - SEE ELECTRICAL/PHOTOMETRICS
- STEEL POST AND GLASS GUARDRAIL
- SECTIONAL OR COILING GARAGE DOOR - FACTORY FINISH - SEE SCHEDULE
- EXHAUST FAN LOWERS/SCREEN - PAINTED
- BUILDING TENANT SIGNAGE - UNDER SEPARATE PERMIT AND SUBMITTAL
- TUBE STEEL GUARDRAIL WITH LAMINATED GLASS PANELS - COLORED FILM BETWEEN GLASS TO MATCH PAINT COLOR SPECIFIED
- CANTILEVERED PT CONCRETE SLAB BALCONY OR OVERHANG - PAINTED
- EDGE OF PT CONCRETE SLAB - PAINTED


COLORS

- PANEL:** DUNN EDWARDS DE / BENJAMIN MOORE BM / PITTSBURGH PAINTS PPG
- A1: MAIN FIELD - BLDG. I (OFF WHITE) PPS 15-08 WHITE CHIP - LRV 71
- A2: MAIN FIELD - BLDG. II (LIGHT GRAY) BM OC-14 NATURAL CREAM - LRV 65
- A3: ACCENT - BLDG. I (DARK GRAY) DE 6384 IRON FIXTURE - LRV 10
- A4: ACCENT - BLDG. I (YELLOW) PPS 1209-6 BRASS MESH - LRV 41
- A5: ACCENT - BLDG. II (BLUE) DE 5768 MYSTERIOUS BLUE - LRV 16
- ALUMINUM WINDOWS, SLIDING GLASS DOORS AND STOREFRONT:** (MILGARD / ARCADIA)
- B1: MILGARD CLEAR ANODIZED
- B2: ARCADIA AB-6 DARK BRONZE ANODIZED
- MASONRY:** (SUPERLITE BLOCK / TRENTWITH INDUSTRIES)
- C1: BLDG. I 8X8X16 TRENTSTONE GROUNDFACE - PEARL
- C2: BLDG. II 8X8X16 TRENTSTONE GROUNDFACE - RUTHERFORD
- C3: BLDG. I&II 8X8X16 MESASTONE TEXTURED - BLACK MOUNTAIN
- METAL PANEL SIDING:**
- D1: WOOD GRAIN SIDING - LONGBOARD - LIGHT NATIONAL WALNUT 1806/02-716
- D2: FLAT STANDING SEAM - STEELSCOPE - VINTAGE
- D3: HORIZONTAL - ENGLERT (H-16-4) - PREWEATHERED GALVALUME
- D4: STANDING SEAM - ENGLERT - DARK BRONZE
- FIBER CEMENT PANEL (CEMENT)**
- E1: CEMENT GRAPHITE 922
- WOOD SIDING - 1/2" T&G RANDOM LENGTHS FROM 3/4"**
- G1: NOWWOOD IROKOCLEAR
- G2: H&WAIN TIMBER CO. CHARRED COLLECTION CYPRESS KUJAKU
- G3: H&WAIN TIMBER CO. CHARRED COLLECTION CYPRESS HOWATO

GENERAL NOTES

- EIFS SYSTEM TO BE SENERGY SENERFLEX CHANNELLED ADHESIVE DESIGN OVER 1" OR 2" INSULATION BOARD, WITH FINE TEXTURE INTEGRAL COLORED FINISH TO MATCH PAINT COLOR. SPECIFIED SYSTEM TO BE INSTALLED OVER WATER RESISTIVE BARRIER COATING, PER THE FOLLOWING EVALUATION REPORTS:
ESR-1878 SENERGY SENERFLEX CHANNELLED ADHESIVE DESIGN OR APPROVED EQUAL
- ALL CONTROL JOINTS & REVEALS TO TERMINATE ON INSIDE CORNERS ONLY. VERIFY LOCATION WITH ARCHITECT.
- PROVIDE SEALANT AT ALL EIFS PENETRATIONS.
- PAINT ALL EXTERIOR MOUNTED ELECTRICAL AND MECHANICAL PANELS/BOXES TO MATCH ADJACENT SURFACE OF THE BUILDING.
- PAINT ALL VENTS, FLASHING, ETC. TO MATCH ADJ. BUILDING COLOR. U.N.O.
- ALL EIFS COLOR CHANGES TO TERMINATE ON INSIDE CORNERS ONLY.
- ALL EXPOSED CMU TO BE WATERSEALED
- ALL EXPOSED DRYER AND EXHAUST VENTS TO BE ALIGNED HORIZONTALLY (AT EACH FLOOR), AND VERTICALLY (FROM FLOOR TO FLOOR) AND PAINTED TO MATCH ADJACENT EIFS COLOR
- RESIDENTIAL WINDOWS TO HAVE DUAL INSULATED GLAZING WITH SUNCOAT LOW-E MIN. U-FACTOR: 0.31 (SLIDING DOORS); .49 (OPERABLE MESH); .40 FIXED WINDOWS MIN. SHGC: .25
- STOREFRONT GLAZING TO BE 1" DUAL INSULATED CLEAR GLAZING MIN. U-FACTOR: 0.47 MIN. SHGC: 0.28

KEYPLAN

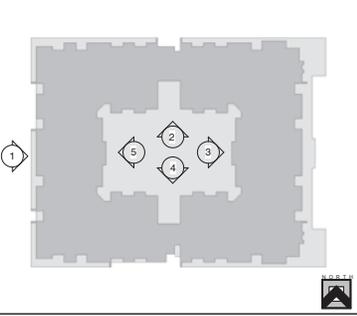

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4422 N. DAVIS CENTER PLAZA
SUITE 202
SCOTTSDALE, AZ 85251
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EASTLINE
VILLAGE
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Revisions		
#	Description	Date

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JOB NUMBER:
DRAWN BY: AD
CHECKED BY: KS
ISSUE DATE: 06/22/2016



SHEET TITLE:
Bldg I -
Building Elevations
SHEET NUMBER:

A2.11

PAD / DPR #3



1 Bldg I - North Elevation
1/16" = 1'-0"



2 Bldg I - West Elevation
1/16" = 1'-0"



3 Bldg I - South Elevation
1/16" = 1'-0"

MATERIAL / COLOR SCHEDULE

MATERIAL / KEYNOTE: $\frac{A-X}{Y-Z}$
COLOR: _____

MATERIALS / KEYNOTES

1. EPS SYSTEM OVER 1" EPS INSULATION BOARD - INTEGRAL COLOR TO MATCH PAINT COLOR SPECIFIED
2. EPS SYSTEM OVER 2" EPS INSULATION BOARD - INTEGRAL COLOR TO MATCH PAINT COLOR SPECIFIED
3. CAST IN PLACE CONCRETE WALL - SMOOTH/NATURAL FINISH
4. CAST IN PLACE CONCRETE COLUMN - SMOOTH/NATURAL FINISH
5. CAST IN PLACE CONCRETE PLANTER - SMOOTH/NATURAL FINISH
6. CAST IN PLACE BOARD FORMED CONCRETE PLANTER - NATURAL FINISH
7. EXPOSED MASONRY - RUNNING BOND, RAKED JOINTS
8. BALCONY FACIA - POWDERCOATED T-BAR AND EPS TO MATCH PAINT COLOR SPECIFIED
9. TUBE STEEL AND WIRE MESH (WIRECRAFTERS SPECIAL MESH 2" x 2" x 8 GA)
10. RAILING/GUARDRAIL - PAINTED
11. STEEL COLUMN - PAINTED
12. CANTILEVERED STEEL FRAME CANOPY WITH PERFORATED MESH PANELS - PAINTED
13. TUBE STEEL FRAME AND WIRE MESH (WIRECRAFTERS SPECIAL MESH 2" x 2" x 8 GA)
14. SECURITY SCREEN - PAINTED
15. VERTICAL STANDING SEAM WALL PANEL SYSTEM
16. HORIZONTAL METAL WALL PANEL SYSTEM
17. WOOD GRAIN ALUMINUM WALL SIDING PANEL SYSTEM
18. FIBER CEMENT WALL PANEL SYSTEM
19. T&G WOOD PANEL SIDING
20. ALUMINUM STOREFRONT - FACTORY FINISH - SEE SCHEDULE
21. HOLLOW METAL DOOR AND FRAME - PAINTED - SEE SCHEDULE
22. SLIDING ALUMINUM GLASS PATIO DOORS - FACTORY FINISH - SEE SCHEDULE
23. FIXED SINGLE SLIDING ALUMINUM WINDOW - FACTORY FINISH - SEE SCHEDULE
24. STANDING SEAM METAL ROOF
25. 20W ALUM. TUBE TRUSS - UNPAINTED
26. STEEL COLUMN / CUSTOM LIGHT FIXTURE
27. WALL MOUNTED LIGHT FIXTURE - SEE ELECTRICAL/PHOTOMETRICS
28. STEEL POST AND GLASS GUARDRAIL
29. SECTIONAL OR COILING GARAGE DOOR - FACTORY FINISH - SEE SCHEDULE
30. EXHAUST FAN LOWERS/SCREEN - PAINTED
31. BUILDING/TENANT SIGNAGE - UNDER SEPARATE PERMIT AND SUBMITTAL
32. TUBE STEEL GUARDRAIL WITH LAMINATED GLASS PANELS - COLORED FILM BETWEEN GLASS TO MATCH PAINT COLOR SPECIFIED
33. CANTILEVERED PT CONCRETE SLAB BALCONY OR OVERHANG - PAINTED
34. EDGE OF PT CONCRETE SLAB - PAINTED

COLORS

- PAINT: DUNN EDWARDS DE / BENJAMIN MOORE BM / PITTSBURGH PAINTS PPG
 A1. MAIN FIELD - BLDG. I (OFF WHITE) PPS 15-09 WHITE CHIP LRV 71
 A2. MAIN FIELD - BLDG. II (LIGHT GRAY) BM CC-14 NATURAL CREAM LRV 65
 A3. ACCENT - BLDG. I (DARK GRAY) DE 6384 IRON FUTURE LRV 10
 A4. ACCENT - BLDG. I (YELLOW) PPS 1209-6 BRASS MESH LRV 41
 A5. ACCENT - BLDG. II (BLUE) DE 5768 MYSTERIOUS BLUE LRV 16

- ALUMINUM WINDOWS, SLIDING GLASS DOORS AND STOREFRONT: (MILGARD / ARCADIA)
 B1. MILGARD CLEAR ANODIZED
 B2. ARCADIA AB-6 DARK BRONZE ANODIZED

- MASONRY: (SUPERLITE BLOCK / TRENTON INDUSTRIES)
 C1. BLDG. I 8X8X16 TRENTONSTONE GROUNDFACE - PEARL
 C2. BLDG. II 8X8X16 TRENTONSTONE GROUNDFACE - RUTHERFORD
 C3. BLDG. III 8X8X16 MESASTONE TEXTURED - BLACK MOUNTAIN

- METAL PANEL SIDING:
 D1. WOOD GRAIN SIDING - LONGBOARD - LIGHT NATIONAL WALNUT 1806/02-716
 D2. FLAT STANDING SEAM STEELSCAPE - VINTAGE
 D3. HORIZONTAL ENGLERT (H-16-4) - PREWEATHERED GALVALUME
 D4. STANDING SEAM ENGLERT - DARK BRONZE


- FIBER CEMENT PANEL (CEMENTI)
 E1. CEMENTI GRANITE 922

- WOOD SIDING - 1/2" T&G RANDOM LENGTHS FROM 8'-0"
 G1. NOWWOOD IROKOCLEAR
 G2. HSAVIN TIMBER CO. CHARRED COLLECTION CYPRESS KUJAKU
 G3. HSAVIN TIMBER CO. CHARRED COLLECTION CYPRESS HOWARTO

GENERAL NOTES

1. EPS SYSTEM TO BE SENERGY SENERFLEX CHANNELLED ADHESIVE DESIGN OVER 1" OR 2" INSULATION BOARD WITH TEXTURE INTEGRAL COLORED FINISH TO MATCH PAINT COLOR SPECIFIED. SYSTEM TO BE INSTALLED OVER WATER RESISTIVE BARRIER COATING PER THE FOLLOWING EVALUATION REPORTS:
 ESR-1878 SENERGY SENERFLEX CHANNELLED ADHESIVE DESIGN OR APPROVED EQUAL
2. ALL CONTROL JOINTS & REVEALS TO TERMINATE ON INSIDE CORNERS ONLY. VERIFY LOCATION WITH ARCHITECT.
3. PROVIDE SEALANT AT ALL EPS PENETRATIONS.
4. PAINT ALL EXTERIOR MOUNTED ELECTRICAL AND MECHANICAL PANELS/BOXES TO MATCH ADJACENT SURFACE OF THE BUILDING.
5. PAINT ALL VENTS, FLASHING, ETC. TO MATCH ADJ. BUILDING COLOR. U.N.O.
6. ALL EPS COLOR CHANGES TO TERMINATE ON INSIDE CORNERS ONLY.
7. ALL EXPOSED DRYER AND EXHAUST VENTS TO BE ALIGNED HORIZONTALLY (AT EACH FLOOR), AND VERTICALLY (FROM FLOOR TO FLOOR) AND PAINTED TO MATCH ADJACENT EPS COLOR
8. RESIDENTIAL WINDOWS TO HAVE DUAL INSULATED GLAZING WITH SUNCOAT LOW-E MIN. U-FACTOR: 0.31 (SLIDING DOORS), .40 (FIXED WINDOWS MIN. SHGC: .25
9. STOREFRONT GLAZING TO BE 1" DUAL INSULATED CLEAR GLAZING MIN. U-FACTOR: 0.47 MIN. SHGC: 0.28

KEYPLAN

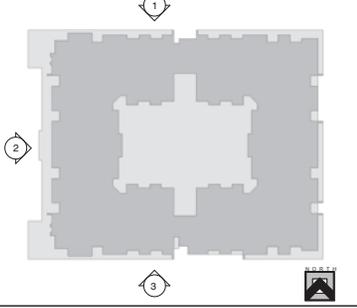

K & J HOMES, LLC
 4422 N. OVAL CENTER PLAZA
 SUITE 202
 SCOTTSDALE, AZ 85251
 PH: 480-970-8900



uhhc
 URBAN HOME
 DEVELOPMENT
 CORPORATION

DMB

EASTLINE
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Revisions

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JOB NUMBER:
 DRAWN BY: AD
 CHECKED BY: KS
 ISSUE DATE: 06/22/2016



SHEET TITLE:
Bldg II -
 Building Elevations
 SHEET NUMBER:
A3.10

PAD / DPR #3



1 Bldg I - East Elevation
1/16" = 1'-0"



2 Bldg I - South Courtyard Elevation
1/16" = 1'-0"



4 Bldg I - North Courtyard Elevation
1/16" = 1'-0"



3 Bldg I - West Courtyard Elevation
1/16" = 1'-0"



5 Bldg I - East Courtyard Elevation
1/16" = 1'-0"

MATERIAL / COLOR SCHEDULE

MATERIAL / KEYNOTE
COLOR - 

MATERIALS / KEYNOTES

- EIFS SYSTEM OVER 1" EPS INSULATION BOARD - INTEGRAL COLOR TO MATCH PAINT COLOR SPECIFIED
- EIFS SYSTEM OVER 2" EPS INSULATION BOARD - INTEGRAL COLOR TO MATCH PAINT COLOR SPECIFIED
- CAST IN PLACE CONCRETE WALL - SMOOTH/NATURAL FINISH
- CAST IN PLACE CONCRETE COLUMN - SMOOTH/NATURAL FINISH
- CAST IN PLACE CONCRETE PLANTER - SMOOTH/NATURAL FINISH
- CAST IN PLACE BOARD FORMED CONCRETE PLANTER - NATURAL FINISH
- EXPOSED MASONRY - RUNNING BOND, RAKED JOINTS
- BALCONY FACIA - POWDERCOATED T-BAR AND EIFS TO MATCH PAINT COLOR SPECIFIED
- TUBE STEEL AND WIRE MESH (WIRECRAFTERS SPECIAL MESH 2" x 2" x 8 GA) RAILING/GUARDRAIL - PAINTED
- STEEL COLUMN - PAINTED
- CANTILEVERED STEEL FRAME CANOPY WITH PERFORATED MESH PANELS - PAINTED
- TUBE STEEL FRAME AND WIRE MESH (WIRECRAFTERS SPECIAL MESH 2" x 2" x 8 GA) SECURITY SCREEN - PAINTED
- VERTICAL STANDING SEAM WALL PANEL SYSTEM
- HORIZONTAL METAL WALL PANEL SYSTEM
- WOOD GRAIN ALUMINUM WALL SIDING PANEL SYSTEM
- FIBER CEMENT WALL PANEL SYSTEM
- T&G WOOD PANEL SIDING
- ALUMINUM STOREFRONT - FACTORY FINISH
- ALUMINUM STOREFRONT DOORS - FACTORY FINISH - SEE SCHEDULE
- HOLLOW METAL DOOR AND FRAME - PAINTED - SEE SCHEDULE
- SLIDING ALUMINUM GLASS PATIO DOORS - FACTORY FINISH - SEE SCHEDULE
- FIXED SINGLE SLIDING ALUMINUM WINDOW - FACTORY FINISH - SEE SCHEDULE
- STANDING SEAM METAL ROOF
- 2X6 ALUM. TRUSS TRUSS - POWDERCOATED
- STEEL COLUMN / CUSTOM LIGHT FIXTURE
- WALL MOUNTED LIGHT FIXTURE - SEE ELECTRICAL/PHOTOMETRICS
- STEEL POST AND GLASS GUARDRAIL
- SECTIONAL OR COILING GARAGE DOOR - FACTORY FINISH - SEE SCHEDULE
- EXHAUST FAN LOW/SCREEN - PAINTED
- BUILDING TENANT SIGNAGE - UNDER SEPARATE PERMIT AND SUBMITTAL
- TUBE STEEL GUARDRAIL WITH LAMINATED GLASS PANELS - COLORED FILM BETWEEN GLASS TO MATCH PAINT COLOR SPECIFIED
- CANTILEVERED PT CONCRETE SLAB BALCONY OR OVERHANG - PAINTED
- EDGE OF PT CONCRETE SLAB - PAINTED

COLORS

PANEL: DUNN EDWARDS DE / BENJAMIN MOORE BM / PITTSBURGH PAINTS PPG
 A1. MAIN FIELD - BLDG. I (OFF WHITE) PPS 15-08 WHITE CHIP LRV 71
 A2. MAIN FIELD - BLDG. II (LIGHT GRAY) BM OC-14 NATURAL CREAM LRV 65
 A3. ACCENT - BLDG. III (DARK GRAY) DE 0384 IRON FIXTURE LRV 10
 A4. ACCENT - BLDG. I (YELLOW) PPS 1209-6 BRASS MESH LRV 41
 A5. ACCENT - BLDG. II (BLUE) DE 0768 MYSTERIOUS BLUE LRV 16

ALUMINUM WINDOWS, SLIDING GLASS DOORS AND STOREFRONT: (MILGARD / ARCADIA)
 BT. MILGARD CLEAR ANODIZED
 BS. ARCADIA AB-6 DARK BRONZE ANODIZED
 MASONRY: (SUPERLITE BLOCK / TRENTON INDUSTRIES)
 C1. BLDG. I 8X8X16 TRENSTONE GROUNDFACE - PEARL
 C2. BLDG. II 8X8X16 TRENSTONE GROUNDFACE - RUTHERFORD
 C3. BLDG. III 8X8X16 MESASTONE TEXTURED - BLACK MOUNTAIN


METAL PANEL SIDING:
 D1. WOOD GRAIN SIDING - LONGBOARD - LIGHT NATIONAL WALNUT 1806/02-716
 D2. FLAT STANDING SEAM STEELSCAPE - VINISAGE
 D3. HORIZONTAL ENGLERT (H-16-4) - PREWEATHERED GALVALUME
 D4. STANDING SEAM ENGLERT - DARK BRONZE

FIBER CEMENT PANEL (CEMENT)
 E1. CEMENT GBRPTE 922
 WOOD SIDING - 1/2" T&G RANDOM LENGTHS FROM B-20
 G1. NOWWOOD IROKOCLEAR
 G2. HSAVIN TIMBER CO. CHARRED COLLECTION CYPRESS-KUJUKU
 G3. HSAVIN TIMBER CO. CHARRED COLLECTION CYPRESS-HOWATO

GENERAL NOTES

- EIFS SYSTEM TO BE SENERGY SENERFLEX CHANNELLED ADHESIVE DESIGN OVER 1" OR 2" INSULATION BOARD, WITH FINE TEXTURE INTEGRAL COLORED FINISH TO MATCH PAINT COLOR SPECIFIED. SYSTEM TO BE INSTALLED OVER WATER RESISTIVE BARRIER COATING, PER THE FOLLOWING EVALUATION REPORTS:
 ESR-1878 SENERGY SENERFLEX CHANNELLED ADHESIVE DESIGN
 OR APPROVED EQUAL
- ALL CONTROL JOINTS & REVEALS TO TERMINATE ON INSIDE CORNERS ONLY. VERIFY LOCATION WITH ARCHITECT.
- PROVIDE SEALANT AT ALL EIFS PENETRATIONS.
- PAINT ALL EXTERIOR MOUNTED ELECTRICAL AND MECHANICAL PANELS/BOXES TO MATCH ADJACENT SURFACE OF THE BUILDING.
- PAINT ALL VENTS, FLASHING, ETC. TO MATCH ADJ. BUILDING COLOR. U.N.O.
- ALL EIFS COLOR CHANGES TO TERMINATE ON INSIDE CORNERS ONLY.
- ALL EXPOSED OMI TO BE WATERSEALED
- ALL EXPOSED DRYER AND EXHAUST VENTS TO BE ALIGNED HORIZONTALLY (AT EACH FLOOR), AND VERTICALLY (FROM FLOOR TO FLOOR) AND PAINTED TO MATCH ADJACENT EIFS COLOR
- RESIDENTIAL WINDOWS TO HAVE DUAL INSULATED GLAZING WITH SUNCOAT LOW-E MIN U-FACTOR: 0.31 (SLIDING DOORS), .40 (OPERABLE WINDOWS), .40 FIXED WINDOWS MIN. SHGC: .25
- STOREFRONT GLAZING TO BE 1" DUAL INSULATED CLEAR GLAZING MIN. U-FACTOR: 0.47 MIN. SHGC: 0.28

KEYPLAN

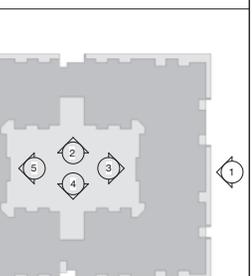

K & J HOMES, LLC
 4422 N. DAVIS CENTER PLAZA
 SUITE 202
 SCOTTSDALE, AZ 85251
 PH: 480-970-8900



VILLAGE
EASTLINE
 LIVE - WORK - PLAY
 APACHE BLVD. REDEVELOPMENT
 TEMPE, ARIZONA

Revisions

#	Description	Date

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JOB NUMBER:
 DRAWN BY: AD
 CHECKED BY: KS
 ISSUE DATE: 06/22/2016



SHEET TITLE:
Bldg I - Building Elevations
 SHEET NUMBER:

A3.11

PAD / DPR #3

EASTLINE BLDG. I MATERIALS/COLORS

FINISH (DANA EDWARDS CO. / BENJAMIN MOORE / THE PITTSBURGH PAINTS PPS) LRV %

A1 MAIN FELD. BLDG. I (OFF WHITE) PPS 15-08 WHITE CHIP LRV 71

A2 ACCENT - BLDG. I#1 (DARK GRAY) DE 8084 ROYAL FUTURE LRV 28

A4 ACCENT - BLDG. I (YELLOW) PPS 1204-6 BRIDGE MESH LRV 41

ALUMINUM WINDOWS, SLIDING GLASS DOORS AND STOREFRONTS: MILWAUKEE / ARCADIA

B1 MILWAUKEE AB-8 CLEAR ANODIZED

B2 ARCADIA AB-8 DARK BRONZE ANODIZED

MASONRY: SUPPLIERS BLOCK / TREMURTH INDUSTRIES

C1 BLDG. I #8084 TREMURTH QUORANCE PEARL

C2 BLDG. I#1 #8084 TREMURTH QUORANCE BLACK MOUNTAIN

WOOD SIDING: THE T&G RANDOM LENGTHS FROM # 22

C3 HEAVY TRIMBER CO. - CHARNER COLLECTION CYPRESS ALUMINUM

A4 - EFIS Accent Color

A1 - EFIS Main Color

B1 - Alum Doors & Windows

A3 - EFIS & A1 Steel Color

C1 CMU - Trexstone

C2 CMU - Trexstone

C3 CMU - Trexstone

G2 Wood Siding at Lobby

EASTLINE BLDG. II MATERIALS/COLORS

FINISH (DANA EDWARDS CO. / BENJAMIN MOORE / THE PITTSBURGH PAINTS PPS) LRV %

A1 MAIN FELD. BLDG. II (OFF WHITE) PPS 15-08 WHITE CHIP LRV 71

A2 ACCENT - BLDG. II#1 (DARK GRAY) DE 8084 ROYAL FUTURE LRV 28

A5 ACCENT - BLDG. II (BLUE) DE 5708 MYSTERIOUS BLUE LRV 14

ALUMINUM WINDOWS, SLIDING GLASS DOORS AND STOREFRONTS: MILWAUKEE / ARCADIA

B1 MILWAUKEE AB-8 CLEAR ANODIZED

B2 ARCADIA AB-8 DARK BRONZE ANODIZED

MASONRY: SUPPLIERS BLOCK / TREMURTH INDUSTRIES

C2 BLDG. II #8084 TREMURTH QUORANCE ALTHORP

C3 BLDG. II#1 #8084 TREMURTH QUORANCE BLACK MOUNTAIN

WOOD SIDING: THE T&G RANDOM LENGTHS FROM # 22

C3 HEAVY TRIMBER CO. - CHARNER COLLECTION CYPRESS HOWARD

A5 - EFIS Accent Color

A2 - EFIS Main Color

B1 - Alum Doors & Windows

A3 - EFIS & A1 Steel Color

C2 CMU - Trexstone

C3 CMU - Trexstone

G3 Wood Siding at Lobby

EASTLINE BLDG. I&II SIDING MATERIALS/COLORS

METAL PANEL SIDING:

D1 RIBBED STANDING SEAM LONGBOARD LIGHT NATIONAL W/SLIP 18x10 1/4"

D2 FLAT STANDING SEAM STEELCASE 1/4"X4"

D3 CORRUGATED ENGLISH 18x14-6 TRUSSEA-PERF GALVALUME

D4 STANDING SEAM ENGLISH DARK BRONZE

FIBER CEMENT PANEL (CAMBRIE)

E1 - CAMBRIE - CAPRIE #82

WOOD SIDING: THE T&G RANDOM LENGTHS FROM # 22

D1 - TRUSSEA-PERF #82

D1 - Alum Woodgrain Siding

E4 Fiber Cement Panel

D2 Vertical Standing Seam

D4 Standing Seam Roof

D3 Horizontal Panel

G1 Wood Siding

K & I HOMES, LLC
 4422 N. DAVIS CENTER BLVD.
 SUITE 202
 SCOTTSDALE, AZ 85251
 PH: 480-970-8900

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JOB NUMBER:
 DRAWN BY: AD
 CHECKED BY: KS
 ISSUE DATE: 06/22/2016

32897
 KRISTIAN SOUSSIGNON

K. Kristian

SHEET TITLE:
 Color Board


SHEET NUMBER:
CB-1

PAD / DPR #3

Englert "H" Series

The Englert H-12 and H-16 are multi-purpose metal wall panels designed for horizontal and vertical applications. The Englert H-12 is a 12" coverage panel, and the H-16 Panel provides 16" of coverage. Both panels are 7/8" deep, with ribs uniformly spaced at 4" on center with a fastening leg, and lock, that is concealed. Panels are coated with an ULTRA-Cool™, Kynar 500® paint finish.

For a system specific to your needs and design please contact an Englert representative.

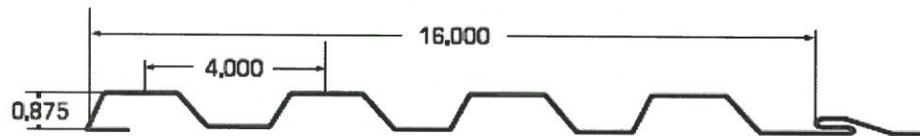

H-16-4

Color Chart

Wire Drawings



H-16-4
ENGLERT "H" SERIES

Profile at a Glance

✓ Structural	✓ ASTM-E283
✓ Architectural detail capability	✓ ASTM-E330
Tight radius curving capacity	✓ ASTM-E331
✓ Florida Building Code Compliance	✓ ASTM-E84
Flush Seam	Exposed Fastener
Horizontal or Vertical application	Concealed Fastener

Alternate Materials


Choose from Special Meshes, Sheet Metal and Lexan

Other materials can be used when our standard 2" x 1" opening mesh does not meet your needs. WireCrafters stocks several different sized meshes, sheet metal, lexan, expanded metal and welded wire for these special applications. Several of

the more popular items are pictured below. Our large inventory and modern manufacturing techniques allow us to make fast delivery of custom product, giving you an edge on the competition.


WireCrafters can upgrade the panel frames to larger angle, and increase the tubing size of the posts to meet your exact requirements. We are experienced with these special projects and welcome them.

special mesh

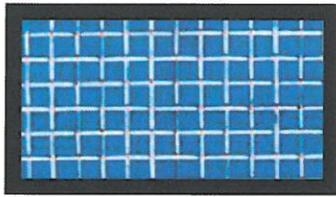


1/2" center-to-center square
12 gauge (3/8" square opening)
 Uses: Any application which requires control over small items.

- Machine guards
- Small liquor bottles
- Federal Reserve
- Drug control

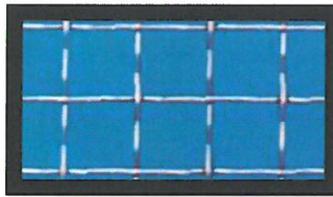


1-5/8" center-to-center square
8 gauge (1-1/2" square opening)
 Uses: Galvanized partitions
 This heavy mesh eliminates warping which may occur during the hot dip galvanize process.
 Also used when our standard 2" x 1" 10 gauge is not strong enough.

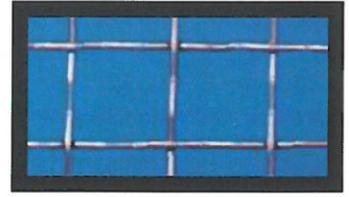


2-1/4" center-to-center square
6 gauge (2" square opening)
 Uses: Heavy duty construction

- Government facility import areas
- Police holding cells
- Prison lockup areas

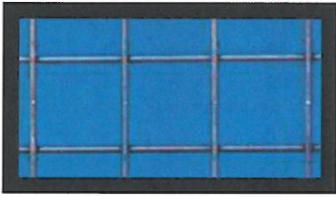

2" center-to-center square
8 gauge welded wire mesh
(1-7/8" square opening)

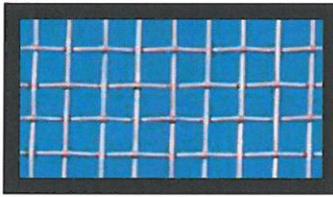


3/4" center-to-center square
10 gauge (5/8" square opening)



1-1/2" diamond mesh
10 gauge

sheet metal, lexan® and expanded metal

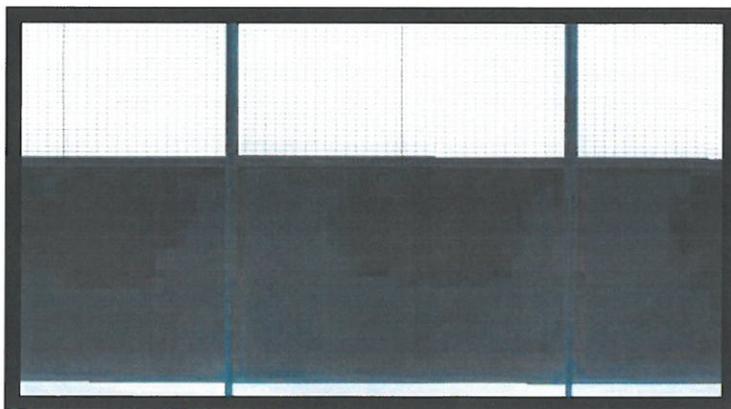


16-GAUGE SHEET METAL



EXPANDED METAL



LEXAN® CLEAR VIEW PANELS

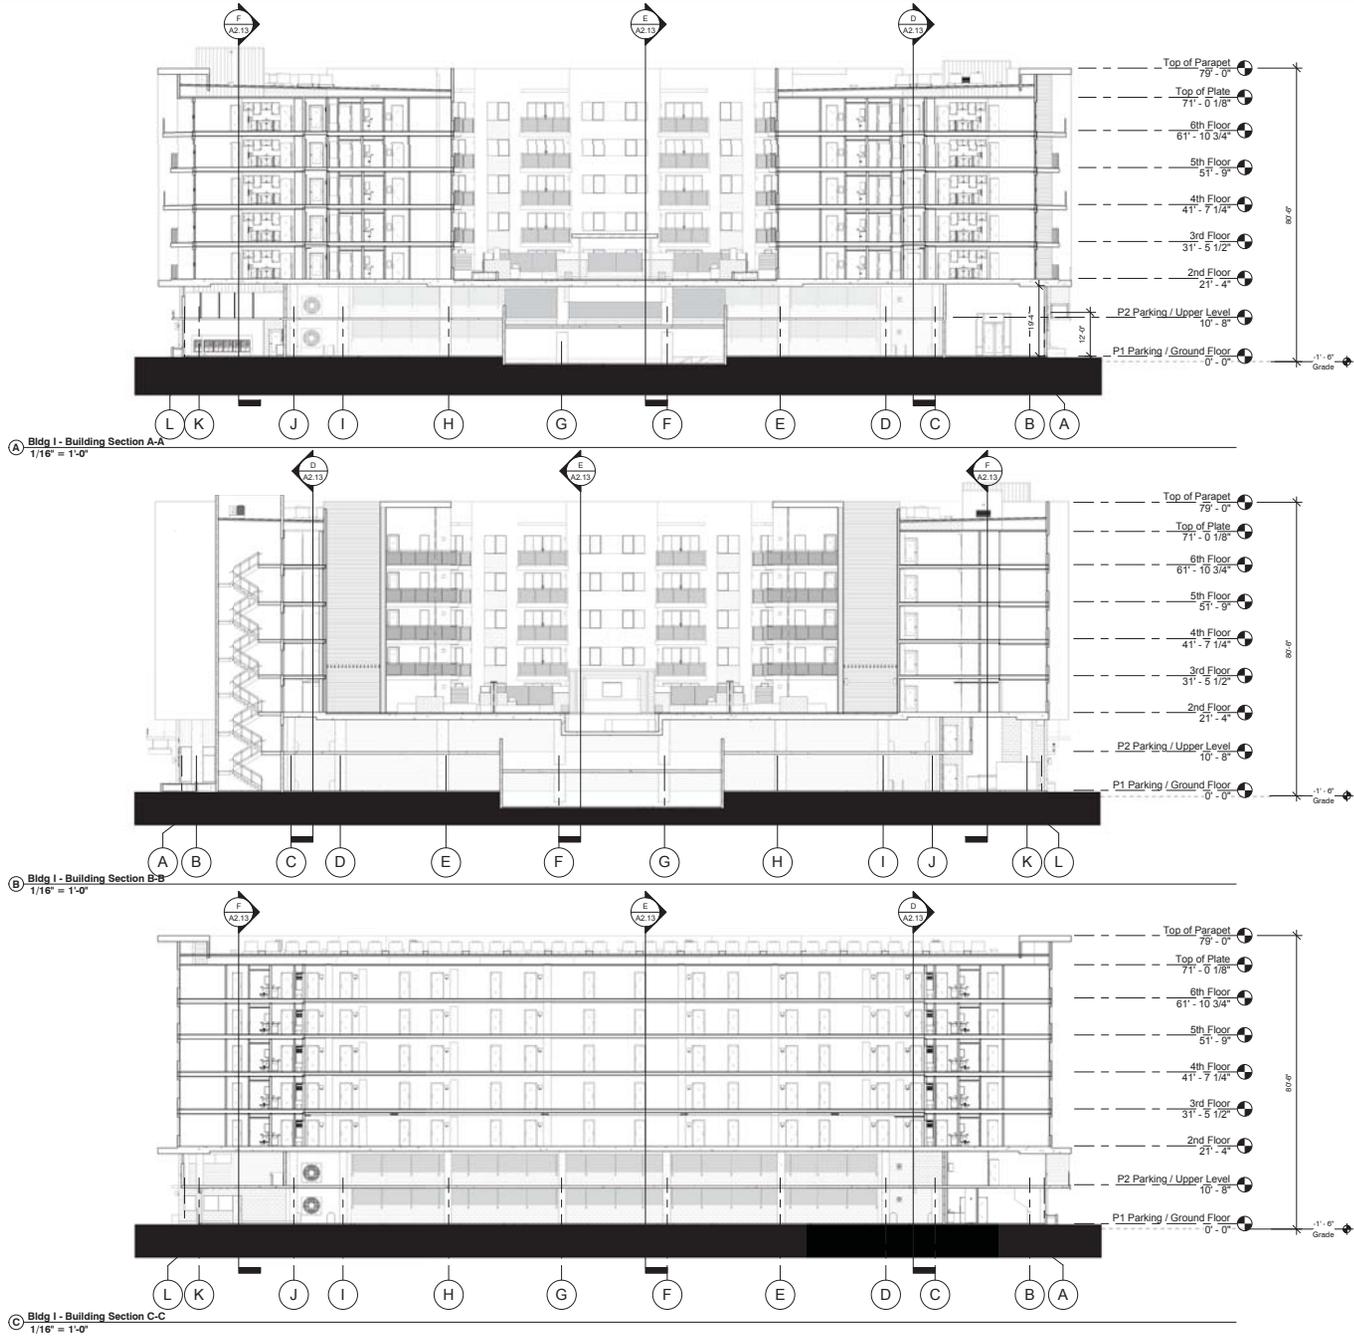


GENERAL NOTES

- R-38 BATT INSULATION AT ROOF / R-19 BATT INSULATION AT EXTERIOR WALLS
- COLUMN AND WALL FOOTINGS SHOWN FOR REFERENCE (SIZE, DEPTH AND REINFORCING BY STRUCTURAL ENGINEER)
- SEE STRUCTURAL DRAWINGS FOR FOUNDATION FOOTING SIZES AND LOCATIONS.
- ALL EXPOSED METALS, ROOF VENTS & STACKS TO BE PAINTED TO MATCH ADJACENT BUILDING SURFACE.
- ALL DIMENSIONS ARE TO FACE OF FRAMING UNLESS NOTED OTHERWISE.
- WALL / PARTITION TYPE INDICATOR, REFER TO DRAWING A0.1 FOR PARTITION TYPES.
- FIRE RATED ASSEMBLIES INDICATOR, REFER TO DRAWING A0.2.1, A0.2.2, & A0.2.3 FOR RATED ASSEMBLIES.
- ALL ROOF FRAMING SHALL BE COMPLETELY SHEATHED AND NAILED UNDER ALL OVER FRAMING WITH A MINIMUM OPENING FOR ACCESS AND ATTIC VENTILATION.
- SEE STRUCTURAL DRAWINGS FOR ALL STRUCTURAL RELATED INFORMATION AND DETAILING INCLUDING ALL TRUSS BLOCKING, ETC. NOT INDICATED ON THIS DRAWING.


SECTION KEYNOTES

- C.I.P. CONCRETE COLUMN - REFER TO STRUCTURAL
- C.I.P. CONCRETE WALL - REFER TO STRUCTURAL
- 4" CONCRETE SLAB ON GRADE
- C.M.U. WALL - REFER TO ELEVATIONS
- CONCRETE DECK - REFER TO STRUCTURAL
- POOL AND SPA
- ELEVATOR, HOISTWAY AND PIT
- CONCRETE SIDEWALK AND/OR PAVERS - REFER TO SITE PLAN
- CORRIDOR WALL
- 1 HR. FLOOR/CEILING ASSEMBLY - REFER TO DETAILS (/A / UNITS), (/A / (CORRIDORS)
- ROOF/CEILING ASSEMBLY, REFER TO DETAIL (/A /
- 1" MIN. THICK CLASS B SPRAY APPLIED RIGID FOAM ROOF SYSTEM WITH CEMENTITIOUS TOP COAT
- AC CONDENSING UNIT
- EPIS SYSTEM OVER WOOD FRAMING - SEE ELEVATIONS
-
-
-
-
-
-

BUILDING KEYPLAN

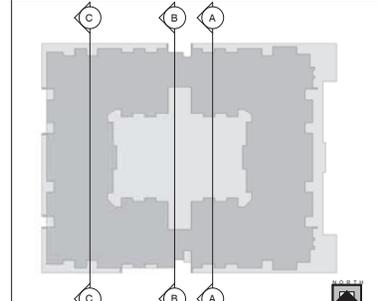

KEYPLAN

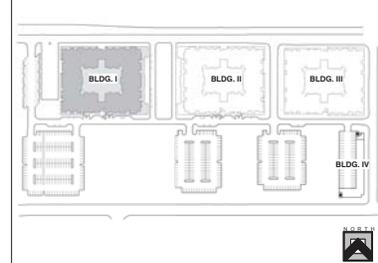

K & I HOMES, LLC
 4422 N. DAVIS CENTER BLVD.
 SUITE 202
 SCOTTSDALE, AZ 85251
 PH: 480-970-8800



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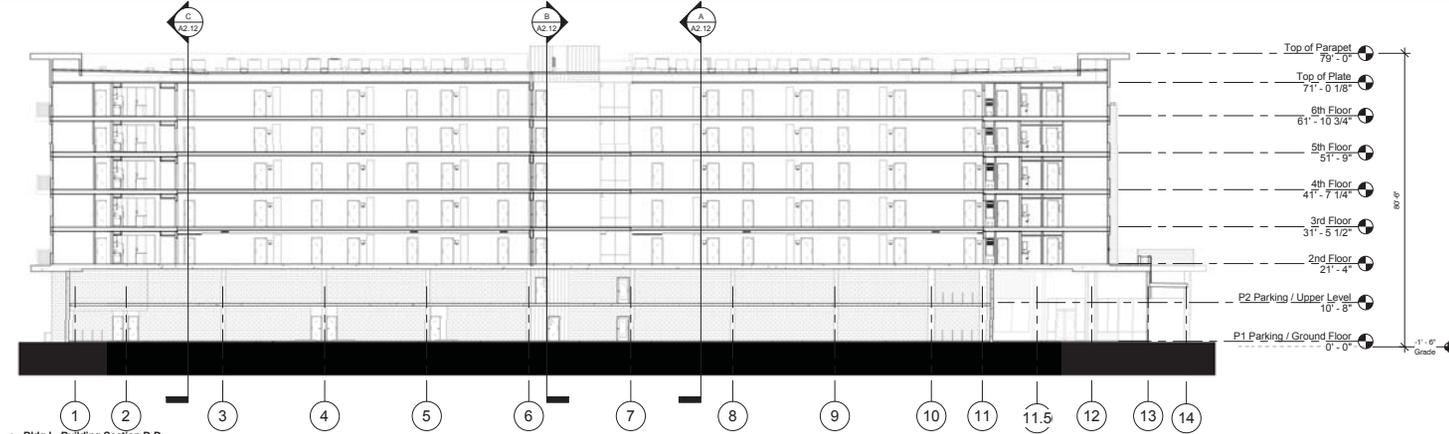
JOB NUMBER:
 DRAWN BY: AD
 CHECKED BY: KS
 ISSUE DATE: 06/22/2016



SHEET TITLE:
 Bldg I - Overall Building Sections
 SHEET NUMBER:

A2.12


PAD / DPR #3



D Bldg I - Building Section D-D
1/16" = 1'-0"



E Bldg I - Building Section E-E
1/16" = 1'-0"

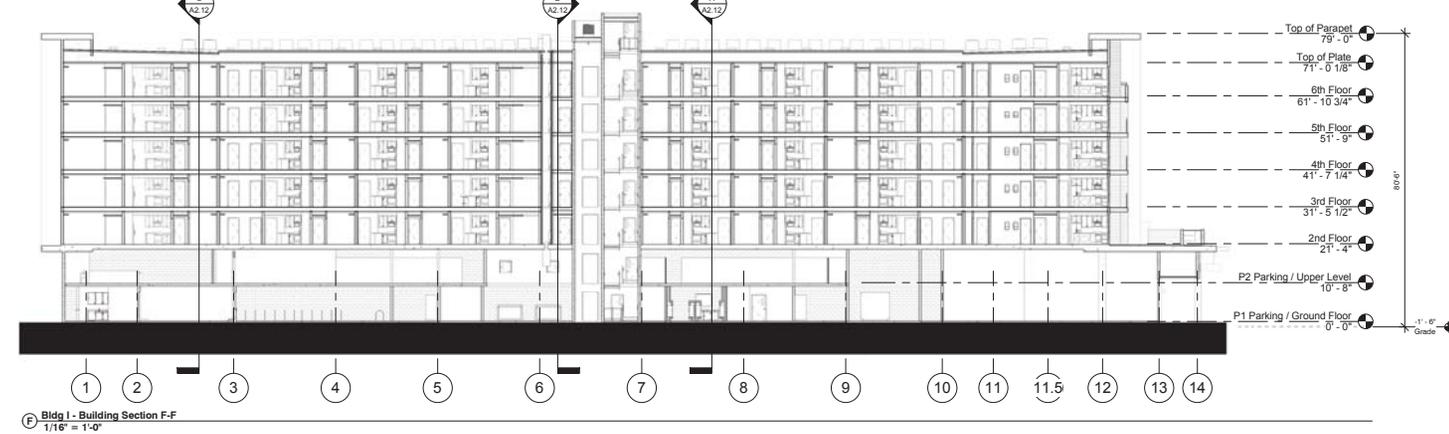

F Bldg I - Building Section F-F
1/16" = 1'-0"


GENERAL NOTES

- R-38 BATT INSULATION AT ROOF / R-19 BATT INSULATION AT EXTERIOR WALLS
- COLUMN AND WALL FOOTINGS SHOWN FOR REFERENCE (SIZE, DEPTH AND REINFORCING BY STRUCTURAL ENGINEER)
- SEE STRUCTURAL DRAWINGS FOR FOUNDATION FOOTING SIZES AND LOCATIONS.
- ALL EXPOSED METALS, ROOF VENTS & STACKS TO BE PAINTED TO MATCH ADJACENT BUILDING SURFACE.
- ALL DIMENSIONS ARE TO FACE OF FRAMING UNLESS NOTED OTHERWISE.
- WALL / PARTITION TYPE INDICATOR, REFER TO DRAWING A0.1 FOR PARTITION TYPES.
- FIRE RATED ASSEMBLIES INDICATOR, REFER TO DRAWING A9.2.1, A9.2.2, & A9.2.3 FOR RATED ASSEMBLIES.
- ALL ROOF FRAMING SHALL BE COMPLETELY SHEATHED AND NAILED UNDER ALL OVER FRAMING WITH A MINIMUM OPENING FOR ACCESS AND ATTIC VENTILATION.
- SEE STRUCTURAL DRAWINGS FOR ALL STRUCTURAL RELATED INFORMATION AND DETAILING INCLUDING ALL TRUSS BLOCKING, ETC. NOT INDICATED ON THIS DRAWING.


SECTION KEYNOTES

- C.I.P. CONCRETE COLUMN - REFER TO STRUCTURAL
- C.I.P. CONCRETE WALL - REFER TO STRUCTURAL
- 4" CONCRETE SLAB ON GRADE
- C.M.U. WALL - REFER TO ELEVATIONS
- CONCRETE DECK - REFER TO STRUCTURAL
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- 1" MIN. THICK CLASS B SPRAY APPLIED RIGID FOAM ROOF SYSTEM WITH CEMENTITIOUS TOP COAT
- AC CONDENSING UNIT
- ERIS SYSTEM OVER DUCT FRAMING - SEE ELEVATIONS
-
-
-
-
-
-

BUILDING KEYPLAN

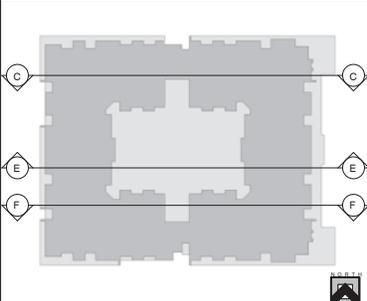

KEYPLAN

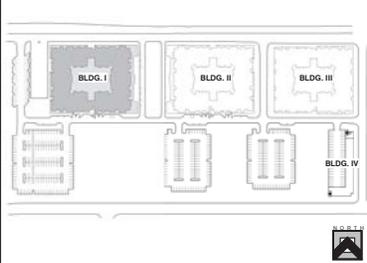

K & J HOMES, LLC
4422 N. QUAD CENTER PLAZA
SUITE 202
SCOTTSDALE, AZ 85251
PH: 480-970-9800



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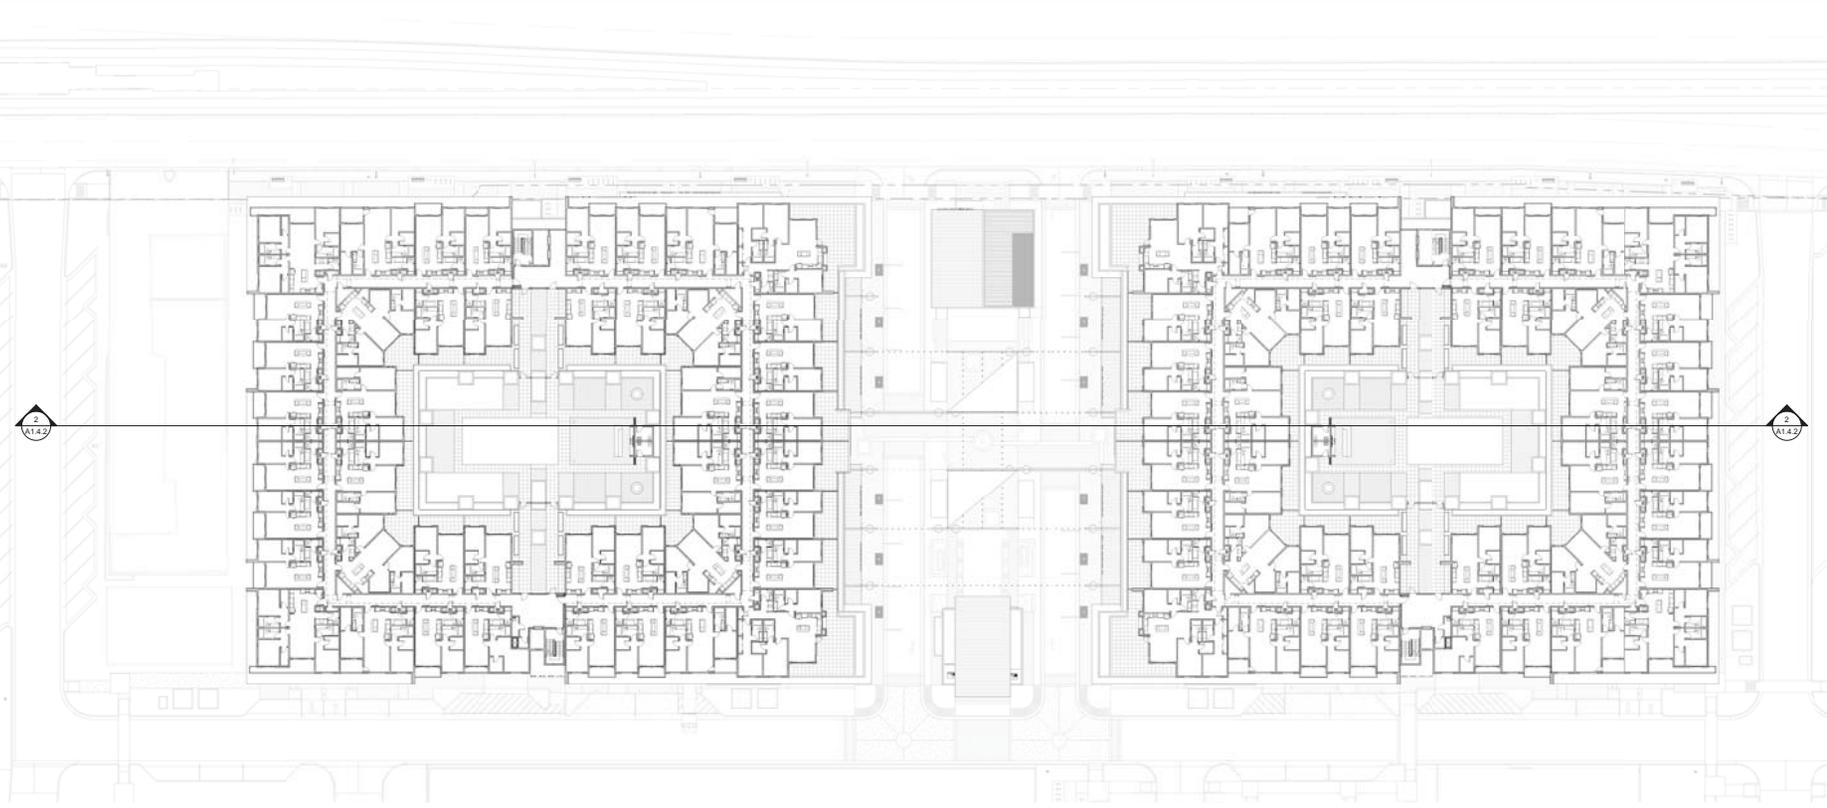
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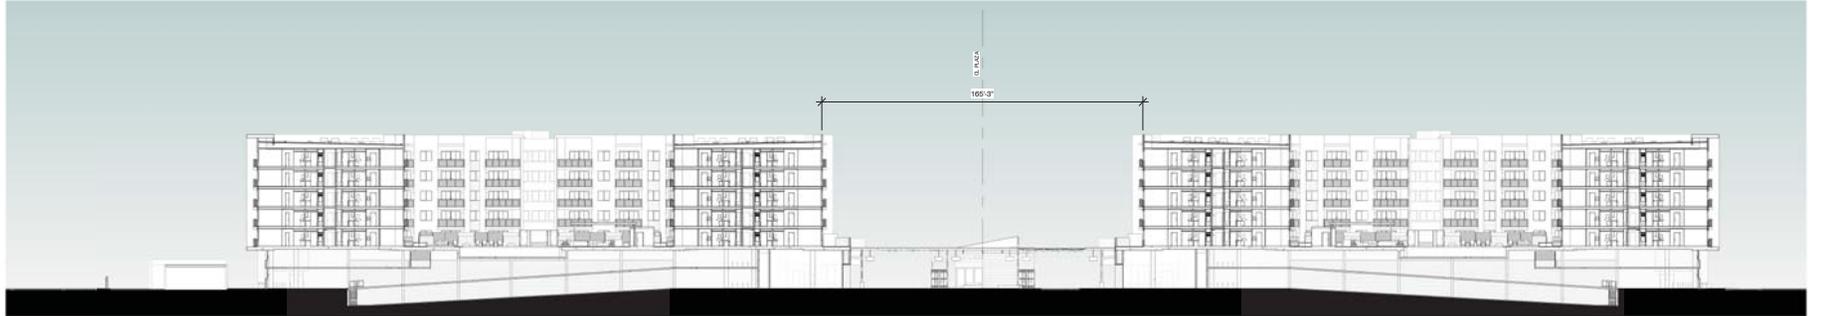
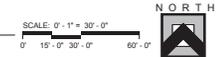
SHEET TITLE:
Bldg I - Overall Building Sections
SHEET NUMBER:

A2.13

PAD / DPR #3



③ SITE PLAN - PHASE I - BLDG I & BLDG II - DECK PARK LEVEL (2nd FLOOR)
1" = 30'-0"



④ Site Section - Bldg I & II - EastWest
1" = 30'-0"

K & I HOMES, LLC
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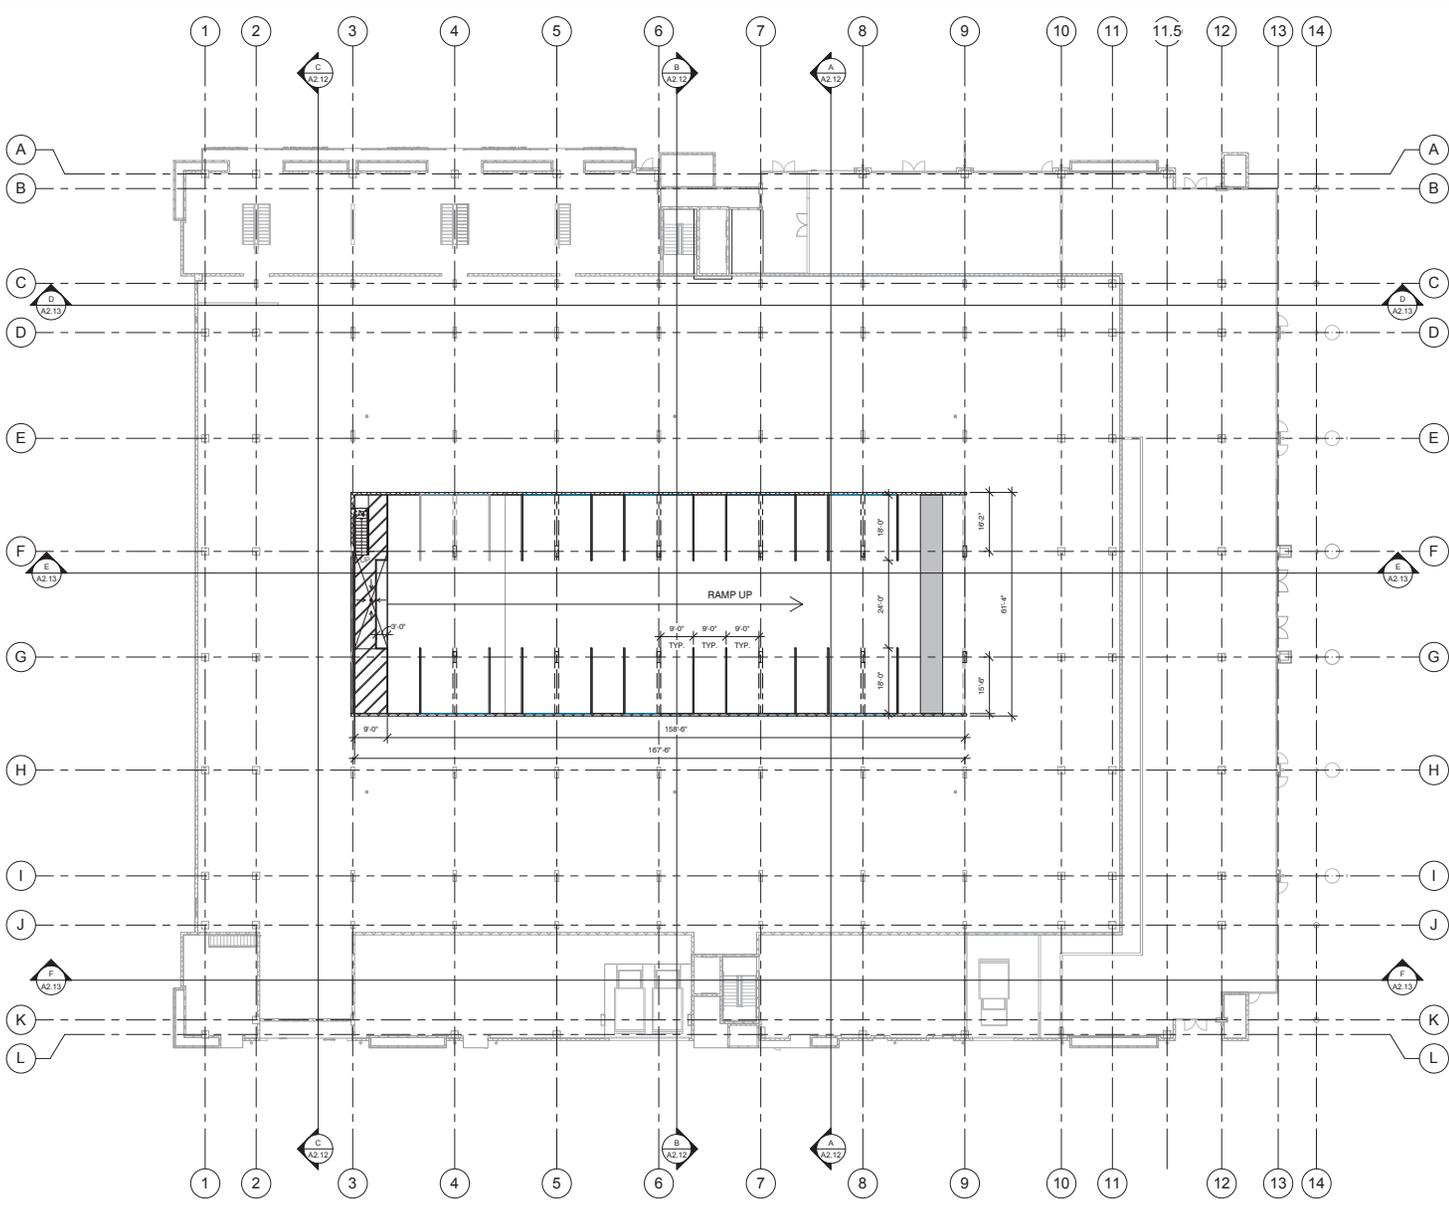
JOB NUMBER:
DRAWN BY: AD
CHECKED BY: KS
ISSUE DATE: 06/22/2016



K. Sourness
SHEET TITLE:
Enlarged Site Plan -
Phase I-Deck Park Lvl
SHEET NUMBER:

A1.4.2

PAD / DPR #3



1 P1 Parking / Ramp Down - Floor Plan - (Bldg II Similar / Mirrored)
1/16" = 1'-0"

SCALE: 0' - 1" = 16'-0"
0' 8'-0" 16'-0" 32'-0"

GENERAL NOTES

- REFER TO GENERAL NOTES ON SHEET A0.1
- UNLESS NOTED OTHERWISE, ALL FLOOR PLAN DIMENSIONS ARE MEASURED FROM:
 - FACE OF MASONRY CONCRETE; ALL MASONRY DIMENSIONS ARE NOMINAL
 - FACE OF PLYWOOD SHEATHING AT FRAME CONDITIONS
 - INTERIOR PARTITIONS: FACE OF STUD
 - CENTERLINE OF COLUMN
- ANGLES ARE 45 DEGREES AND 90 DEGREES - U.N.C.
- ALL ELEVATIONS ARE FROM FINISH ELEVATION OF FFE AT GROUND FLOOR
- GYPSONUM WALL BOARD (GWB) AND FINISHES:
 - SEE GENERAL FINISH NOTES AND INTERIOR ELEVATIONS FOR EXTENT OF GWB
 - PROVIDE CASING BEADS AT GWB EDGES WHEREVER GWB ABUTS A DIFFERENT MATERIAL
 - PROVIDE SQUARED CORNER BEADS AT ALL GWB CORNERS
 - USE WATER RESISTANT GWB ON WALLS OF ALL RESTROOMS, THE KITCHEN BACK WALL, LAUNDRY ROOMS, AND MECHANICAL/WATER HEATER CLOSETS
 - PROVIDE CEMENTITIOUS BACKER BOARD FOR TILE AT ALL TUB AND SHOWER
 - FOR ALL WALL TYPES, PROVIDE INTERIOR FINISHES AS PER GENERAL FINISH NOTES AND INTERIOR ELEVATIONS
- REFER TO SHEETS A0.2.1, A0.2.X FOR FIRE RATING, FIRE STOPPING, FIRE BLOCKING, PENETRATIONS AND SOUND CONTROL
- PROVIDE PORTABLE FIRE EXTINGUISHERS THROUGHOUT IN ACCORDANCE WITH IBC SEC. 906 AND NFPA 10
 - SEMI-RECESSED CABINETS AT FINISHED AREAS
 - SURFACE MOUNTED CABINETS AT EXPOSED CMU WALLS

FLOOR PLAN KEYNOTES

- C.M.U. WALL - REFER TO SECTIONS
- C.I.P. CONCRETE COLUMN - REFER TO STRUCTURAL
- C.I.P. CONCRETE WALL - REFER TO STRUCTURAL
- CONCRETE SLAB O'ABC ON GRADE OR COMPACTED FILL
- PRECAST CONCRETE PARKING CURB - WHERE SHOWN, AND AS REQ'D TO PROTECT ANY EXPOSED PIPING AND CONDUITS ALONG PERIMETER WALL
- 1 HR RATED PAINTED STEEL COLUMN - REFER TO DETAIL X / A0.X
- BIKE RACK - REFER TO COT DETAIL X / X
- TRASH CHUTE FROM TOP FLOOR TO GROUND FLOOR - REFER TO SHEET AX
- PAINTED ACCESSIBLE PARKING SYMBOL AND SIGN ON WALL
- LANDSCAPE PLANTER
- 4" PAINTED PARKING STRIPE
- ELECTRICAL SERVICES & METERS - REFER TO ELECTRICAL
- C.I.P. CONCRETE STAIR
- FLOOR DRAIN - REFER TO PLUMBING
- SLOPE SLAB TO DRAIN
- ALUM. STOREFRONT - REFER TO ELEVATIONS AND SHEET A0.2.X
- CANOPY ROOF ABOVE
- ACCESSIBLE RAMP
- LINE OF DECK, BALCONY OR BUILDING ABOVE
- ROOF OVERHANG ABOVE
- DATA CLOSET - SEE ELECTRICAL
- 1 1/2" H - 12" C.M.U. PLANTER WALL - TILE FRONT & TOP
- 48" H - 8" C.M.U. PLANTER WALL - STUCCO
- 24" H - 4" C.M.U. PLANTER WALL - STUCCO
- 60" H - 8" C.M.U. (TRENDS/STONE) PLANTER WALL W/ 4" SOLID CAP
- LINE OF SHAKE STRUCTURE / CANOPY ABOVE
- 60" HIGH CUSTOM 'GREENSCREEN' POOL FENCE
- 60" STEEL POOL FENCE AND GATE W/ SELF CLOSER & LATCH
- C.M.U. PLANTER - REFER TO DECK PARK PLANS
- C.M.U. PLANTER AND GUARDRAIL - REFER TO ELEVATIONS AND DECK PARK DETAILS
- SERVICE SIGN
- 1 HR STEEL COLUMN - GC OPTION TO MONOKOTE OR DRYWALL WRAP PER DETAIL
- FURN OUT OR UPSIDE SURROUNDINGS STUDS AS REQ'D TO CONCEAL COLUMN
- OPEN TO BELOW
- STEEL GUARDRAIL
- PRECAST CONCRETE PAVERS
- FRP PLANTER (TURNSIDE)
- FIREPIT
- DECK DRAIN
- LINE OF CONCRETE COLUMN BELOW
- SLOPE CONCRETE DECK TO DRAIN AT 1/4" FOOT MIN.
- ROOF BELOW
- ROOF DRAIN AND OVERFLOW IN WALL
- THRU-WALL SCUPPER
- TYP. UNIT ENTRY FEATURE, POP-OUT WALL AND SOFFIT
- FIRE EXTINGUISHER CABINET - REFER TO DETAIL X / A0.X
- NESTING EQUIPMENT ON SHELF
- LIGHT BOLLARD - SEE ELECTRICAL

GENERAL INSULATION NOTES

- PROVIDE INSULATION AT ALL WALLS AND ASSEMBLIES, AS REQUIRED TO ACHIEVE REQUIRED SOUND AND FIRE RATING, PER DETAILS ON SHEETS A0.2.X
- IN GENERAL PROVIDE THE FOLLOWING INSULATION TYPES AND VALUES:

R-30	BATTS	ROOF/CEILING ASSEMBLY
R-11	BATTS	FLOOR/CEILING ASSEMBLY BETWEEN UNITS
R-19	BATTS	ALL EXTERIOR WALLS AND APPLICABLE 2X6 INTERIOR WALLS
3.5"	SOUND BATTS	ALL CORRIDOR WALLS, BOTH SIDES OF UNIT DEMISING WALLS AROUND ALL UNIT BATHROOMS AND LAUNDRY ROOMS

GENERAL FINISH NOTES

- ALL CORRIDORS TO RECEIVE 2X2 COMMERCIAL GRADE CARPET SQUARES - 3 DIFFERENT COLORS/PATTERNS AS SELECTED BY ARCHITECT - 136 PAINTED MDF BASE
- ALL UTILITY AND STORAGE ROOMS TO RECEIVE VCT TILE AND 4" COVERED RUBBER BASE
- ALL HARDROCK CONCRETE AT UNIT BALCONIES TO BE WATER SEALED
- PROVIDE PEDESTRIAN DECK COATING FOR 2ND FLOOR OUTSIDE PERIMETER UNIT BALCONIES

KEYPLAN

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uhdc
URBAN HOME DEVELOPMENT CORPORATION

DMB

EASTLINE
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LIVE - WORK - PLAY
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TEMPE, ARIZONA

Revisions		
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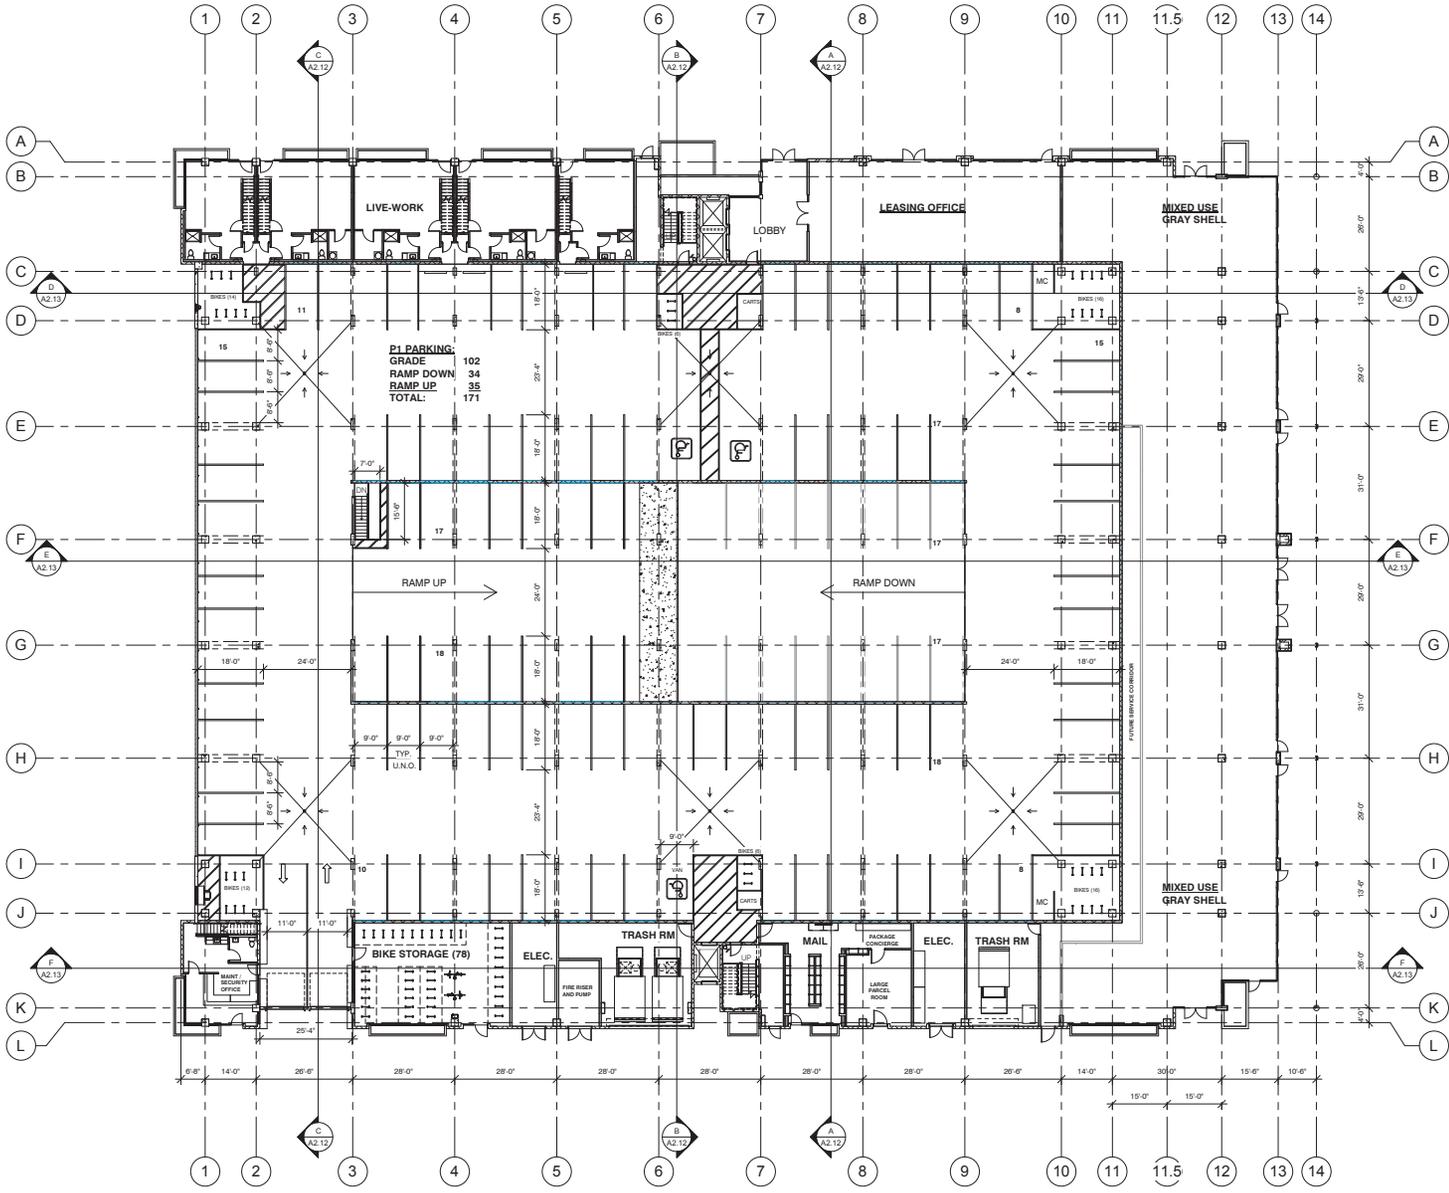
32807
KRISTAN
SOURDISON

K. Sourdison

SHEET TITLE:
Bldg I - P1 Parking / Ramp Down

SHEET NUMBER:
A2.1.0

PAD / DPR #3



① P1 Parking / Ground Floor Plan - (Bldg II Similar / Mirrored)
1/16" = 1'-0"

SCALE: 0' - 1" = 16' - 0"
0' 8' 16' 0" 32' 0"

- ### GENERAL NOTES
- REFER TO GENERAL NOTES ON SHEET A0.1
 - UNLESS NOTED OTHERWISE, ALL FLOOR PLAN DIMENSIONS ARE MEASURED FROM:
 - FACE OF MASONRY CONCRETE AT ALL MASONRY DIMENSIONS ARE NOMINAL
 - FACE OF PLYWOOD SHEATHING AT FRAME CONDITIONS
 - CENTRAL LINE OF COLUMN
 - INTERIOR PARTITIONS, FACE OF STUD
 - ANGLES ARE 45 DEGREES AND 90 DEGREES - U.N.C
 - ALL ELEVATIONS ARE FROM NATURAL ELEVATION 0'-0" FFE AT GROUND FLOOR
 - GYP-SUM WALL BOARD (GWB) AND FINISHES:
 - SEE GENERAL FINISH NOTES AND INTERIOR ELEVATIONS FOR EXTENT OF GWB
 - PROVIDE CASING BEADS AT GWB EDGES WHEREVER GWB ABUTS A DIFFERENT MATERIAL
 - PROVIDE SQUARED CORNER BEADS AT ALL GWB CORNERS
 - USE WATER RESISTANT GWB ON WALLS OF ALL RESTROOMS, THE KITCHEN BACK WALL, LAUNDRY ROOMS, AND MECHANICAL/WATER HEATER CLOSETS
 - PROVIDE CEMENTITIOUS BACKER BOARD FOR TILE AT ALL TUB AND SHOWER
 - FOR ALL WALL TYPES, PROVIDE INTERIOR FINISHES AS PER GENERAL FINISH NOTES AND INTERIOR ELEVATIONS
 - REFER TO SHEETS A0.2.1, A0.2.X FOR FIRE RATING, FIRE STOPPING, FIRE BLOCKING, PENETRATIONS AND SOUND CONTROL
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 - SEMI-RECESSED CABINETS AT FINISHED AREAS
 - SURFACE MOUNTED CABINETS AT EXPOSED CMU WALLS

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 - C.I.P. CONCRETE COLUMN - REFER TO STRUCTURAL
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 - CONCRETE SLAB 0' ABC ON GRADE OR COMPACTED FILL
 - PRECAST CONCRETE PARKING CURB - WHERE SHOWN, AND AS REQ'D TO PROTECT ANY EXPOSED PIPING AND CONDUITS ALONG PERIMETER WALL
 - 1 HR RATED PAINTED STEEL COLUMN - REFER TO DETAIL X / A9.X
 - BIKE RACK - REFER TO DETAIL X / X
 - TRASH CHUTE FROM TOP FLOOR TO GROUND FLOOR - REFER TO SHEET AX
 - PAINTED ACCESSIBLE PARKING SYMBOL AND SIGN ON WALL
 - LANDSCAPE PLANTER
 - PAINTED PARKING STRIPE
 - ELECTRICAL SERVICES & METERS - REFER TO ELECTRICAL
 - C.I.P. CONCRETE STAIR
 - FLOOR DRAIN - REFER TO PLUMBING
 - SLOPE SLAB TO DRAIN
 - ALUM. STOREFRONT - REFER TO ELEVATIONS AND SHEET A0.2.X
 - CANOPY ROOF ABOVE
 - ACCESSIBLE RAMP
 - LINE OF DECK, BALCONY OR BUILDING ABOVE
 - ROOF OVERHANG ABOVE
 - CON. DUCT IN 1 HR RATED SHAFT - SEE TYP. ENLARGED PLAN XA9.X
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 - 1 1/2" C.M.U. PLANTER WALL - TILE FRONT & TOP
 - 4" H - 8" C.M.U. PLANTER WALL - STUCCO
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KEYPLAN

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3287 KRISTAN SOUZZAIN


SHEET TITLE:
Bldg. I - P1 Parking / Ground Level

SHEET NUMBER:
A2.1.1

PAD / DPR #3

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1 Bldg I - P2 Parking / Upper Level - Floor Plan - (Bldg II Similar / Mirrored)
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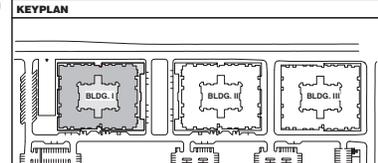


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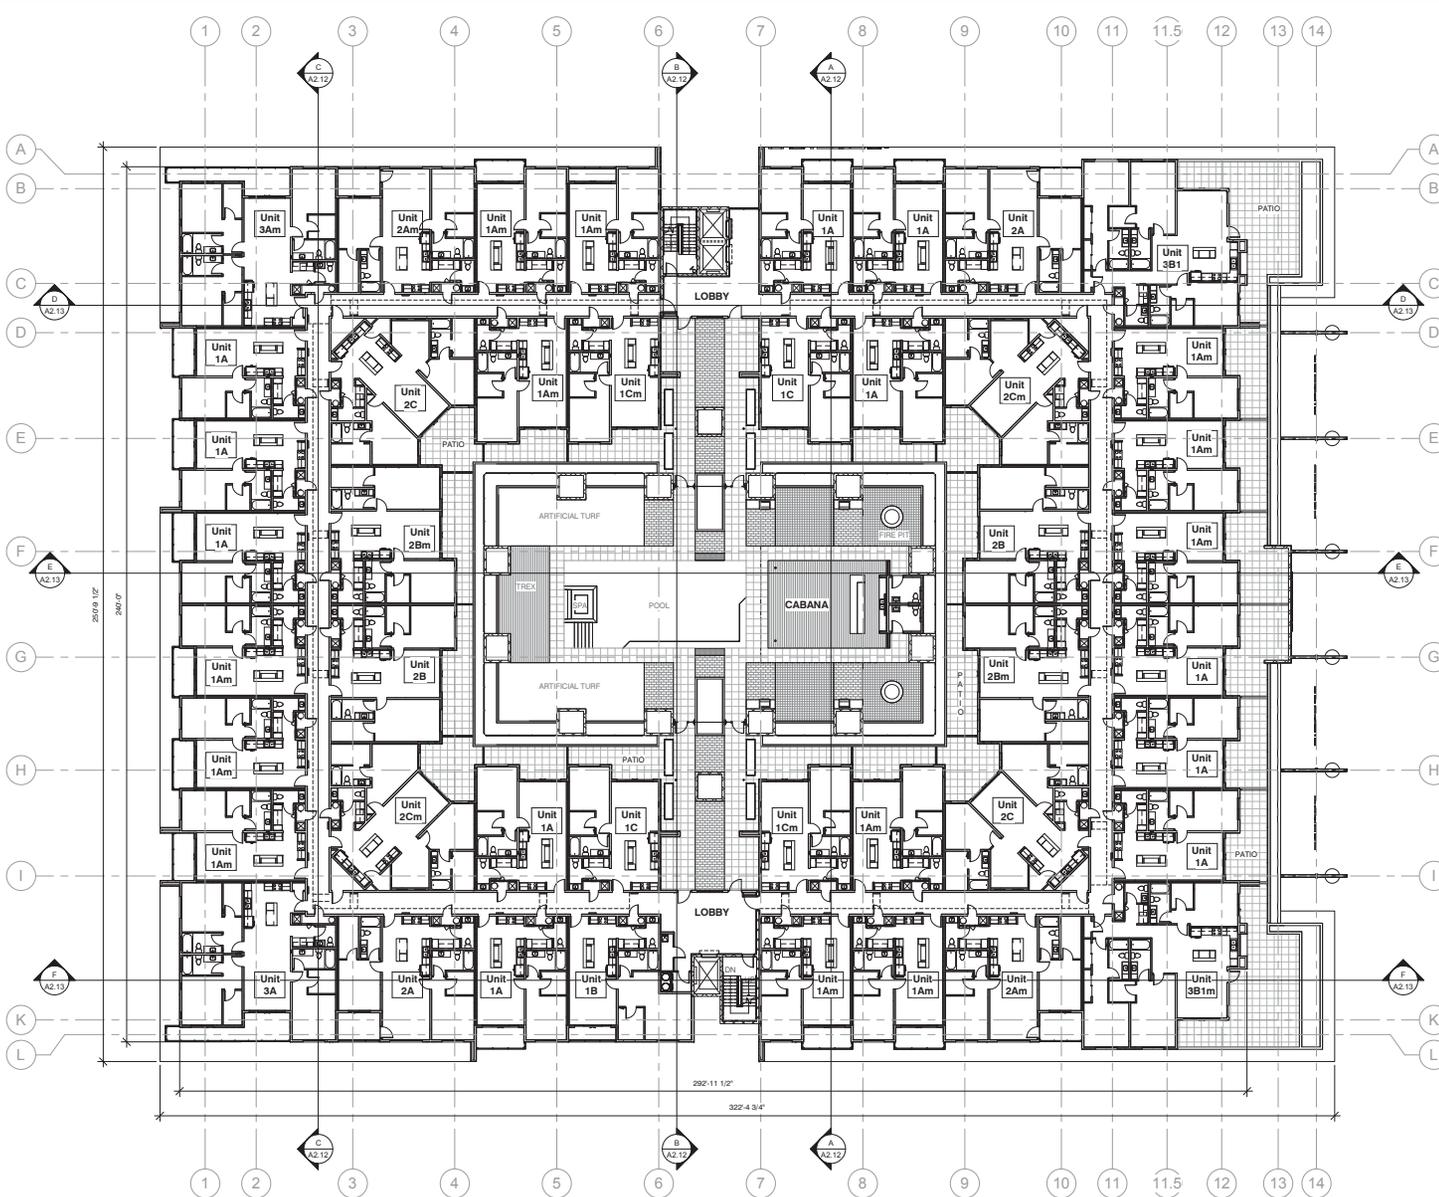
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SHEET TITLE:
 Bldg I - P2 Parking / Upper Level
 SHEET NUMBER:

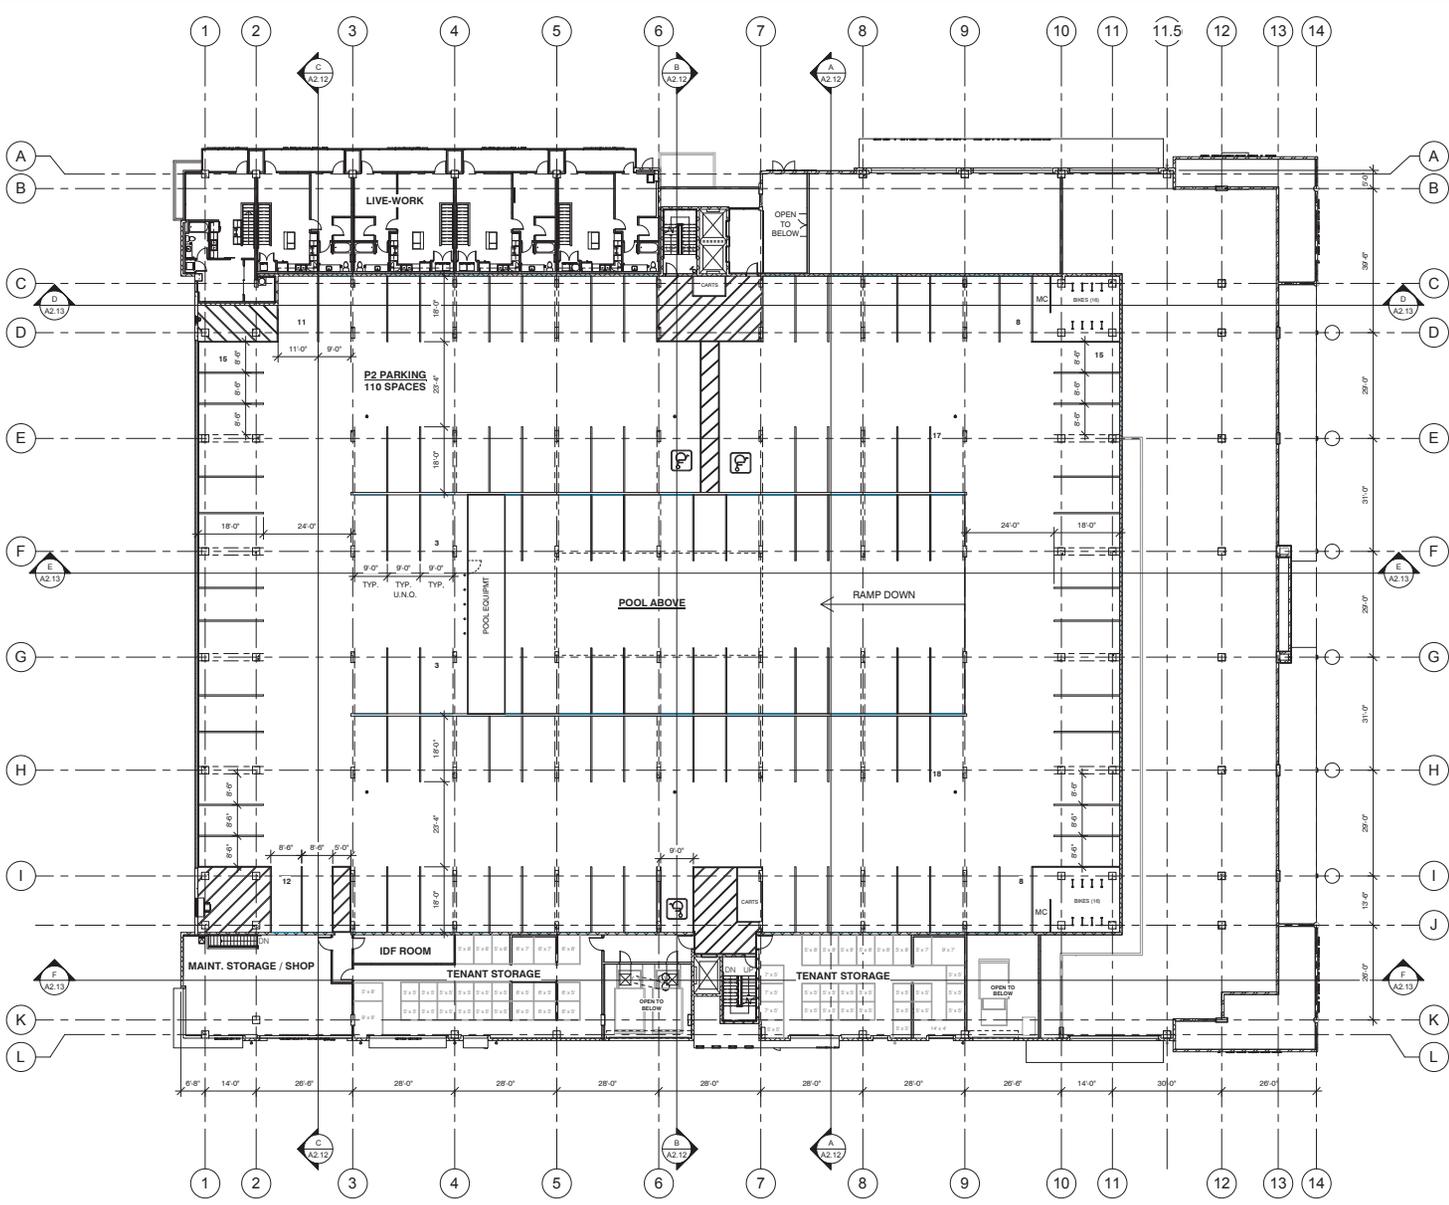A2.1.2

PAD / DPR #3



1 Bldg I - 2nd Floor Plan - (Bldg II Similar / Mirrored)
1/16" = 1'-0"


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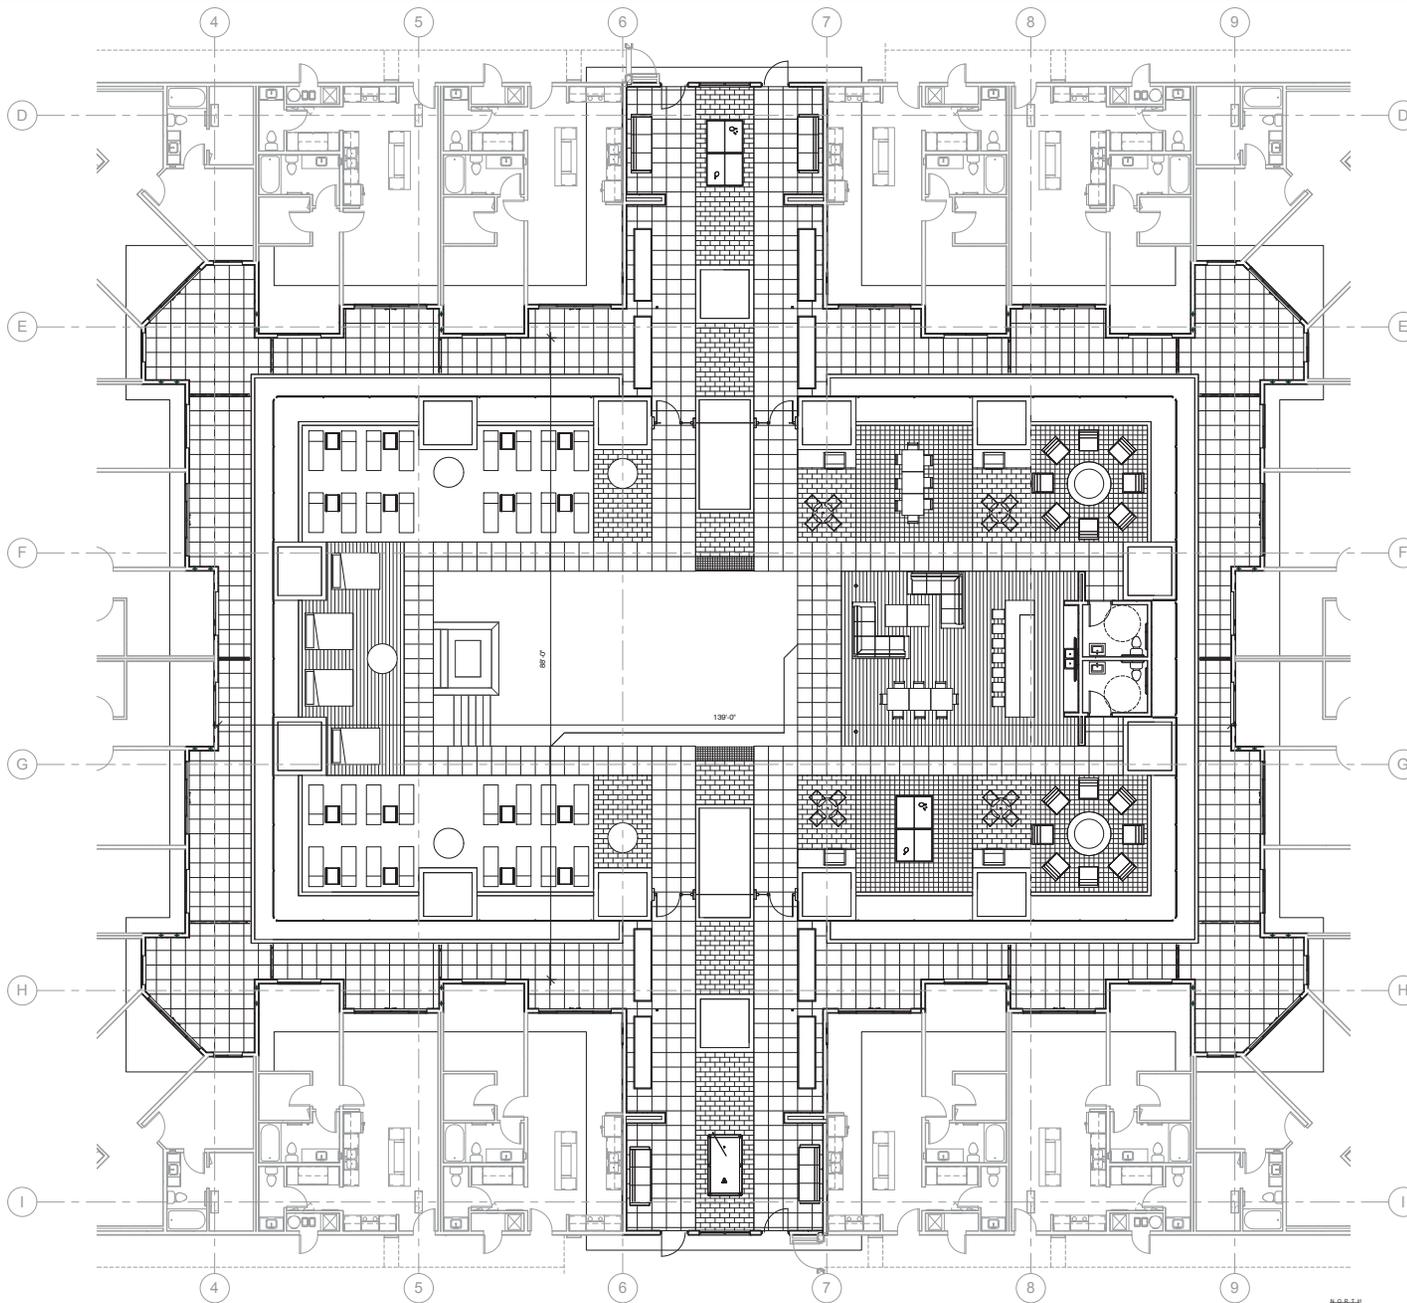
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SHEET TITLE:
 Bldg I -
 2nd Floor Plan
 SHEET NUMBER:

A2.2.1

PAD / DPR #3



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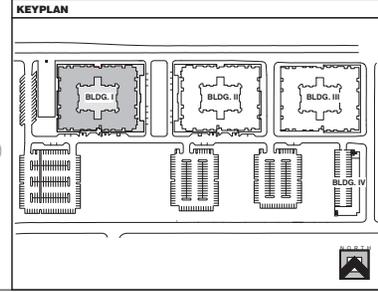
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 - SEE GENERAL FINISH NOTES AND INTERIOR ELEVATIONS FOR EXTENT OF GWB
 - PROVIDE CASING BEADS AT GWB EDGES WHEREVER GWB ABUTS A DIFFERENT MATERIAL. PROVIDE SQUARED CORNER BEADS AT ALL GWB CORNERS.
 - USE WATER RESISTANT GWB ON WALLS OF ALL RESTROOMS, THE KITCHEN BACK WALL, LAUNDRY ROOMS, AND MECHANICAL/WATER HEATER CLOSETS
 - PROVIDE CEMENTITIOUS BACKER BOARD FOR TILE AT ALL TUB AND SHOWER SUBROOMS
 - FOR ALL WALL TYPES, PROVIDE INTERIOR FINISHES AS PER GENERAL FINISH NOTES AND INTERIOR ELEVATIONS
 - REFER TO SHEETS A0.2.1, A0.2.X FOR FIRE RATING, FIRE STOPPING, FIRE BLOCKING, PENETRATIONS AND SOUND CONTROL
 - PROVIDE PORTABLE FIRE EXTINGUISHERS THROUGHOUT IN ACCORDANCE WITH IBC SEC. 906 AND NFPA 10
 - SEMI-RECESSED CABINETS AT FINISHED AREAS
 - SURFACE MOUNTED CABINETS AT EXPOSED CMU WALLS

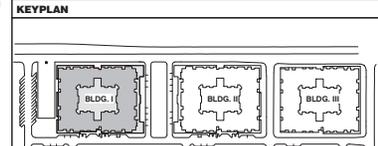- FLOOR PLAN KEYNOTES**
- C.M.U. WALL - REFER TO SECTIONS
 - C.I.P. CONCRETE COLUMN - REFER TO STRUCTURAL
 - C.I.P. CONCRETE WALL - REFER TO STRUCTURAL
 - 4" CONCRETE SLAB @ ABC ON GRADE OR COMPACTED FILL
 - PRECAST CONCRETE PARKING CURB - WHERE SHOWN, AND AS REED TO PROTECT ANY EXPOSED PIPING AND CONDUITS ALONG PERIMETER WALL
 - 1 HR RATED PAINTED STEEL COLUMN - REFER TO DETAIL X / A0.2.X
 - BIKE RACK - REFER TO COT DETAIL X / X
 - TRASH CHUTE FROM TOP FLOOR TO GROUND FLOOR. REFER TO SHEET AX
 - PAINTED ACCESSIBLE PARKING SYMBOL AND SIGN ON WALL
 - LANDSCAPE PLANTER
 - PAINTED PARKING STRIPE
 - ELECTRICAL SERVICES & METERS - REFER TO ELECTRICAL
 - C.I.P. CONCRETE STAIR
 - FLOOR DRAIN - REFER TO PLUMBING
 - SLOPE SLAB TO DRAIN
 - ALUM. STOREFRONT - REFER TO ELEVATIONS AND SHEET A0.2.X
 - CANOPY ROOF ABOVE
 - ACCESSIBLE RAMP
 - LINE OF DECK, BALCONY OR BUILDING ABOVE
 - ROOF OVERHANG ABOVE
 - OA DUCT IN 1 HR RATED SHAFT - SEE TYP. ENLARGED PLAN X0A.0X
 - DATA CLOSET - SEE ELECTRICAL
 - 10" H - 12" C.M.U. PLANTER WALL - TILE FRONT & TOP
 - 40" H - 8" C.M.U. PLANTER WALL - STUCCO
 - 24" H - 4" C.M.U. PLANTER WALL - STUCCO
 - 60" H - 8" C.M.U. (TRENDSHED) PLANTER WALL W/ 4" SOLID CAP
 - LINE OF SHAKE STRUCTURE / CANOPY ABOVE
 - 60" HIGH CUSTOM 'GREENSCREEN' POOL FENCE
 - 60TH STEEL POOL FENCE AND GATE W/ SELF CLOSER & LATCH
 - C.M.U. PLANTER - REFER TO DECK PARK PLANS
 - C.M.U. PLANTER AND GUARDRAIL - REFER TO ELEVATIONS AND DECK PARK DETAILS
 - SERVICE SINK
 - 1 HR STEEL COLUMN - GC OPTION TO MONOKOTE OR DRYWALL WRAP PER DETAIL X0A.2.X
 - FURN OUT OR UPSIDE SURROUNDINGS STUDS AS REED TO CONCEAL COLUMN. OPEN TO BELOW
 - STEEL GUARDRAIL
 - PRECAST CONCRETE PAVERS
 - FRP PLANTER (TOURNESS)
 - FIREFIT
 - DECK DRAIN
 - LINE OF CONCRETE COLUMN BELOW
 - SLOPE CONCRETE DECK TO DRAIN AT 1/4" FOOT MIN.
 - ROOF BELOW
 - ROOF DRAIN AND OVERFLOW IN WALL
 - THRU WALL SCUPPER
 - TYP. UNIT ENTRY FEATURE, POP-OUT WALL AND SOFFIT
 - FIRE EXTINGUISHER CABINET - REFER TO DETAIL X / A0.2.X
 - NEBULATING EQUIPMENT ON SHELF
 - LIGHT BOLLARD - SEE ELECTRICAL

- GENERAL INSULATION NOTES**
- PROVIDE INSULATION AT ALL WALLS AND ASSEMBLIES, AS REQUIRED TO ACHIEVE REQUIRED SOUND AND FIRE RATING. PER DETAILS ON SHEETS A0.2.X
 - IN GENERAL PROVIDE THE FOLLOWING INSULATION TYPES AND VALUES:
 - R-30 BATTs ROOF/CEILING ASSEMBLY
 - R-11 BATTs FLOOR/CEILING ASSEMBLY BETWEEN UNITS
 - R-19 BATTs ALL EXTERIOR WALLS AND APPLICABLE 2X6 INTERIOR WALLS
 - 3.5" SOUND BATTs ALL CORRIDOR WALLS, BOTH SIDES OF UNIT DEMISING WALLS AROUND ALL UNIT BATHROOMS AND LAUNDRY ROOMS

- GENERAL FINISH NOTES**
- ALL CORRIDORS TO RECEIVE 2X2 COMMERCIAL GRADE CARPET SQUARES - 3 DIFFERENT COLORS/PATTERNS AS SELECTED BY ARCHITECT - 136 PAINTED MDF BASE
 - ALL UTILITY AND STORAGE ROOMS TO RECEIVE VCT TILE AND 4" COVERED RUBBER BASE
 - ALL HARDWOOD CONCRETE AT UNIT BALCONIES TO BE WATER SEALED
 - PROVIDE PEDESTRIAN DECK COATING FOR 2ND FLOOR OUTSIDE PERIMETER UNIT BALCONIES



K & I HOMES, LLC
4422 N. QUINN CENTER PLAZA
SUITE 202
SCOTTSDALE, AZ 85251
PH: 480-970-9000



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TEMPE, ARIZONA

Revisions

#	Description	Date


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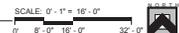
SHEET TITLE:
Bldg I -
Deck Park Plan

SHEET NUMBER:
A2.2.2

PAD / DPR #3



1 Bldg I - 3rd Floor Plan (Floors 3-6 SIM) - (Bldg II Similar / Mirrored)
 1/16" = 1'-0"

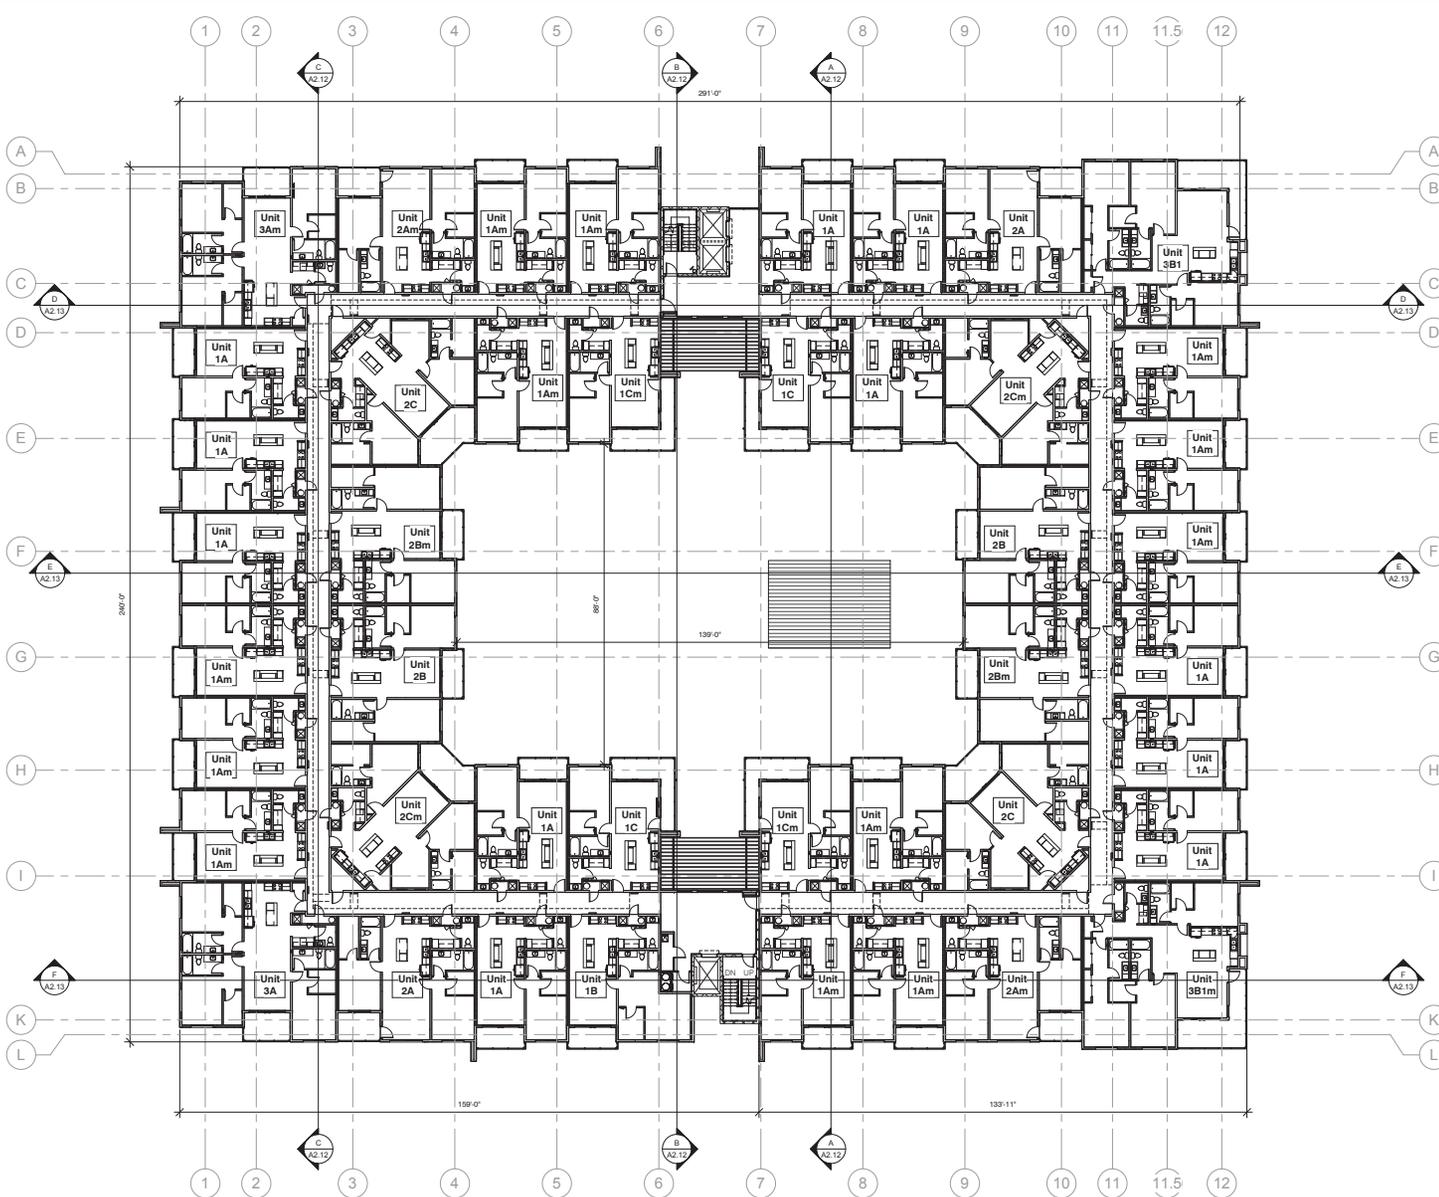


- GENERAL NOTES**
- REFER TO GENERAL NOTES ON SHEET A0.1
 - UNLESS NOTED OTHERWISE, ALL FLOOR PLAN DIMENSIONS ARE MEASURED FROM:
 - FACE OF MASONRY OR CONCRETE; ALL MASONRY DIMENSIONS ARE NOMINAL
 - FACE OF PLYWOOD SHEATHING AT FRAME CONDITIONS
 - INTERIOR PARTITIONS; FACE OF STUD
 - CENTERLINE OF COLUMNS
 - ANGLES ARE 45 DEGREES AND 90 DEGREES - U.N.C
 - ALL ELEVATIONS ARE FROM DATUM ELEVATION 0'0" FFE AT GROUND FLOOR
 - GYPSON WALL BOARD (GWB) AND FINISHES:
 - SEE GENERAL FINISH NOTES AND INTERIOR ELEVATIONS FOR EXTENT OF GWB
 - PROVIDE CASING BEADS AT GWB EDGES WHEREVER GWB ABUTS A DIFFERENT MATERIAL. PROVIDE SQUARED CORNER BEADS AT ALL GWB CORNERS.
 - USE WATER RESISTANT GWB ON WALLS OF ALL RESTROOMS, THE KITCHEN BACK WALL, LAUNDRY ROOMS, AND MECHANICAL/WATER HEATER CLOSETS
 - PROVIDE CEMENTITIOUS BACKER BOARD FOR TILE AT ALL TUB AND SHOWER SURFACES
 - FOR ALL WALL TYPES, PROVIDE INTERIOR FINISHES AS PER GENERAL FINISH NOTES AND INTERIOR ELEVATIONS.
 - REFER TO SHEETS A0.2.1, A0.2.X FOR FIRE RATING, FIRE STOPPING, FIRE BLOCKING, PENETRATIONS AND SOUND CONTROL
 - PROVIDE PORTABLE FIRE EXTINGUISHERS THROUGHOUT IN ACCORDANCE WITH IBC SEC. 906 AND NFPA 10
 - SEMI-RECESSED CABINETS AT FINISHED AREAS
 - SURFACE MOUNTED CABINETS AT EXPOSED CMU WALLS

- FLOOR PLAN KEYNOTES**
- -
 - C.M.U. WALL - REFER TO SECTIONS
 - C.I.P. CONCRETE COLUMN - REFER TO STRUCTURAL
 - C.I.P. CONCRETE WALL - REFER TO STRUCTURAL
 - CONCRETE SLAB O'ABC ON GRADE OR COMPACTED FILL
 - PRECAST CONCRETE PARKING CURB - WHERE SHOWN, AND AS REQ'D TO PROTECT ANY EXPOSED PIPING AND CONDUITS ALONG PERIMETER WALL
 - 1 HR RATED PAINTED STEEL COLUMN - REFER TO DETAIL X / A0.2.X
 - BIKE RACK - REFER TO COT DETAIL X / X
 - TRASH CHUTE FROM TOP FLOOR TO GROUND FLOOR - REFER TO SHEET AX
 - PAINTED ACCESSIBLE PARKING SYMBOL AND SIGN ON WALL
 -
 -
 - LANDSCAPE PLANTER
 - PAINTED PARKING STRIPE
 - ELECTRICAL SERVICES & METERS - REFER TO ELECTRICAL
 - C.I.P. CONCRETE STAIR
 - FLOOR DRAIN - REFER TO PLUMBING
 - SLOPE SLAB TO DRAIN
 - ALUM. STOREFRONT - REFER TO ELEVATIONS AND SHEET A0.2.X
 - CANOPY ROOF ABOVE
 - ACCESSIBLE RAMP
 - LINE OF DECK, BALCONY OR BUILDING ABOVE
 - ROOF OVERHANG ABOVE
 -
 -
 - LANDSCAPE PLANTER
 - PAINTED PARKING STRIPE
 - ELECTRICAL SERVICES & METERS - REFER TO ELECTRICAL
 - C.I.P. CONCRETE STAIR
 - FLOOR DRAIN - REFER TO PLUMBING
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 - CANOPY ROOF ABOVE
 - ACCESSIBLE RAMP
 - LINE OF DECK, BALCONY OR BUILDING ABOVE
 - ROOF OVERHANG ABOVE
 -
 -
 - GA. DUCT IN 1 HR RATED SHAFT - SEE TYP. ENLARGED PLAN X0A.9X
 - DATA CLOSET - SEE ELECTRICAL
 - 1/2" H - 12" C.M.U. PLANTER WALL - TILE FRONT & TOP
 - 4/8" H - 8" C.M.U. PLANTER WALL - STUCCO
 - 24" H - 4" C.M.U. PLANTER WALL - STUCCO
 - 6/8" H - 8" C.M.U. (TRENDSSTONE) PLANTER WALL W/ 4" SOLID CAP
 - LINE OF SHAKE STRUCTURE / CANOPY ABOVE
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 - C.M.U. PLANTER AND GUARDRAIL - REFER TO ELEVATIONS AND DECK PARK DETAILS
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 - FURR OUT OR UPSIDE SURROUNDINGS STUDS AS REQ'D TO CONCEAL COLUMN. OPEN TO BELOW.
 - STEEL GUARDRAIL
 - PRECAST CONCRETE PAVERS
 - FIR PLANTER (TOURNESS)
 -
 - FIREFIT
 - DECK DRAIN
 - LINE OF CONCRETE COLUMN BELOW
 - SLOPE CONCRETE DECK TO DRAIN AT 1/4" FOOT MIN.
 -
 - ROOF BELOW
 - ROOF DRAIN AND OVERFLOW IN WALL
 - THRU-WALL SCUPPER
 - TYP. UNIT ENTRY FEATURE, POP-OUT WALL AND SOFFIT
 - FIRE EXTINGUISHER CABINET - REFER TO DETAIL X / A0.2.X
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 - LIGHT BOLLARD - SEE ELECTRICAL

- GENERAL INSULATION NOTES**
- PROVIDE INSULATION AT ALL WALLS AND ASSEMBLIES, AS REQUIRED TO ACHIEVE REQUIRED SOUND AND FIRE RATING. PER DETAILS ON SHEETS A0.2.X
 - IN GENERAL PROVIDE THE FOLLOWING INSULATION TYPES AND VALUES:
 - R-30 BATTIS ROOF/CEILING ASSEMBLY
 - R-11 BATTIS FLOOR/CEILING ASSEMBLY BETWEEN UNITS
 - R-19 BATTIS ALL EXTERIOR WALLS AND APPLICABLE 2X6 INTERIOR WALLS
 - 3.5" SOUND BATTIS ALL CORRIDOR WALLS, BOTH SIDES OF UNIT DEMISING WALLS AROUND ALL UNIT BATHROOMS AND LAUNDRY ROOMS

- GENERAL FINISH NOTES**
- ALL CORRIDORS TO RECEIVE 2X2 COMMERCIAL GRADE CARPET SQUARES - 3 DIFFERENT COLORS/PATTERNS AS SELECTED BY ARCHITECT - 1/8" PAINTED MDF BASE
 - ALL UTILITY AND STORAGE ROOMS TO RECEIVE VCT TILE AND 4" COVERED RUBBER BASE
 - ALL HARBROCK CONCRETE AT UNIT BALCONIES TO BE WATER SEALED
 - PROVIDE PEDESTRIAN DECK COATING FOR 2ND FLOOR OUTSIDE PERIMETER UNIT BALCONIES

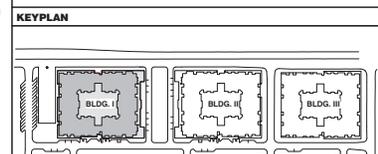

K & I HOMES, LLC
 4422 N. DAVIS CENTER BLVD.
 SUITE 202
 SCOTTSDALE, AZ 85251
 PH: 480-970-8900



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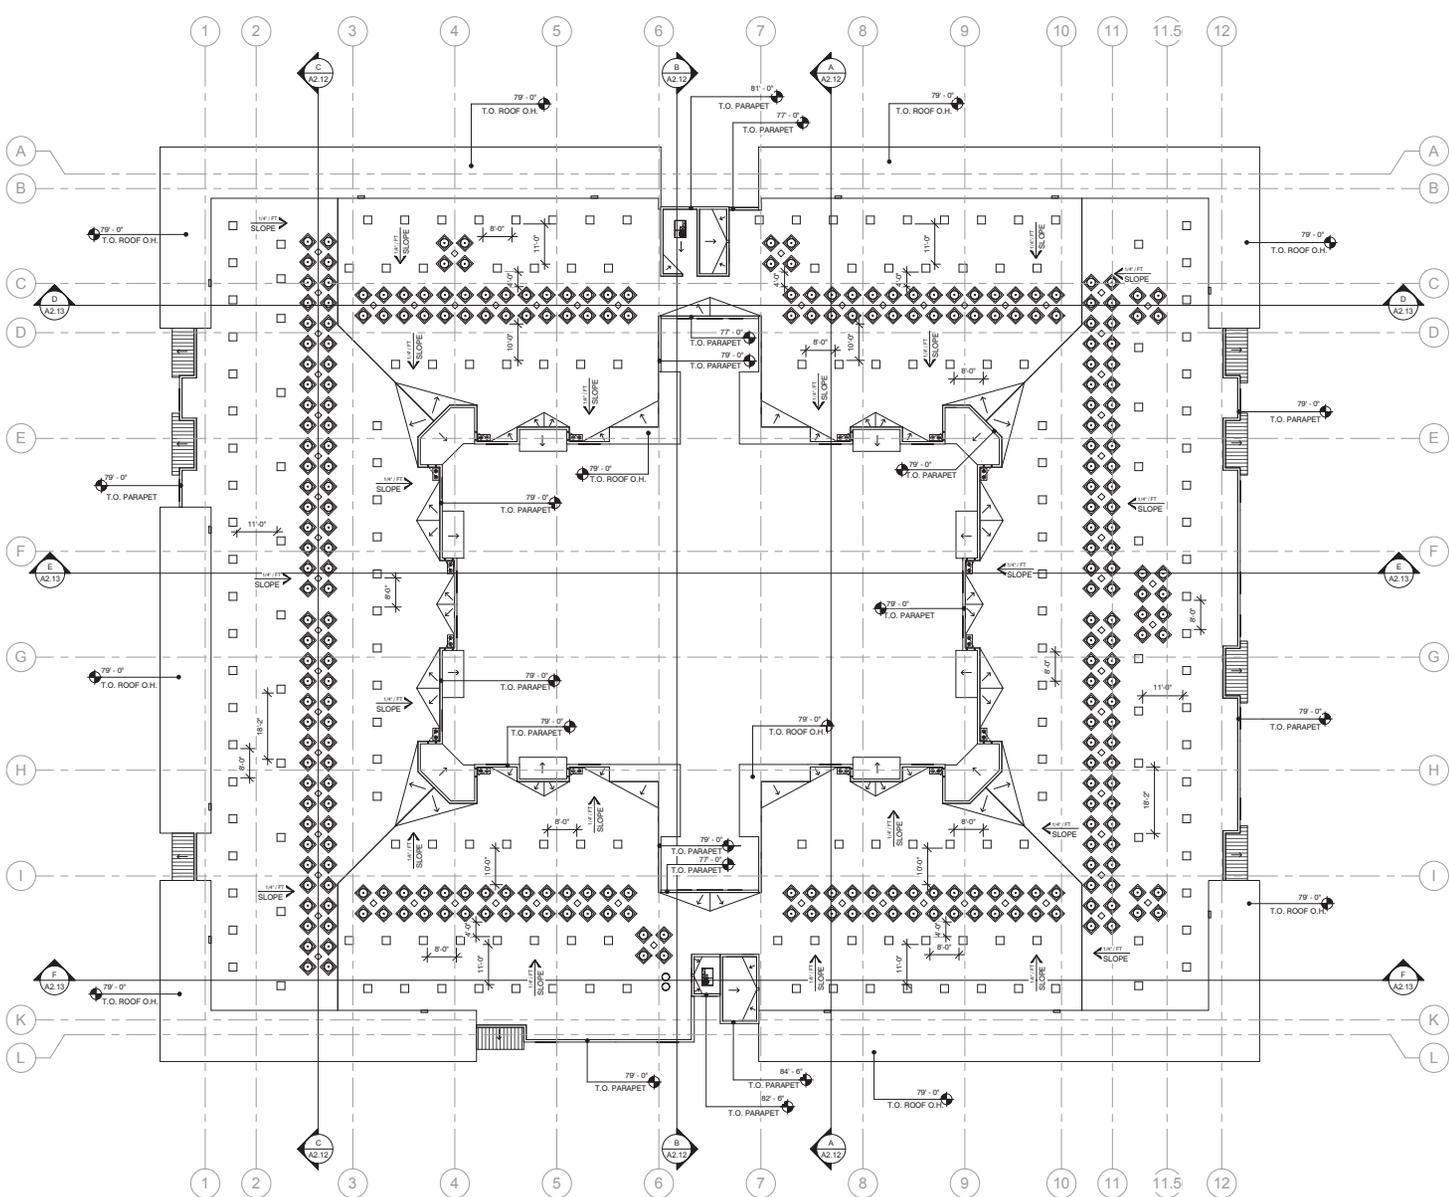
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 DRAWN BY: AD
 CHECKED BY: KS
 ISSUE DATE: 06/22/2016



SHEET TITLE:
 Bldg I -
 3rd Floor Plan
SHEET NUMBER:

A2.3

PAD / DPR #3



1) Bldg I - (Bldg II Similar / Mirrored)
1/16" = 1'-0"

SCALE: 0' - 1" = 16' - 0"
0' 8' 16' 32'

GENERAL ROOF NOTES

- REFER TO GENERAL NOTES ON SHEET A2.1 FOR ADDITIONAL INFORMATION. ALL TOP OF ELEVATIONS SHOWN ARE BASED FROM DATUM FINISH FLOOR ELEVATION 0'-0" AT GROUND FLOOR.
- SEE MECHANICAL, PLUMBING AND ELECTRICAL DRAWINGS FOR ADDITIONAL INFORMATION REGARDING ROOF PENETRATIONS AND ADDITIONAL ITEMS OF COORDINATION NOT SHOWN ON ROOF PLAN.
- ALL AREAS OF THE ROOF SURFACE SHALL MAINTAIN A MIN. 1/4" PER FOOT SLOPE. CRICKET VALLEYS SHALL BE A MINIMUM OF 1/8" PER FOOT SLOPE.
- ALL ROOF MOUNTED EQUIPMENT SHALL BE COMPLETELY SCREENED FROM VIEW BY THE BUILDING PARAPET OR MECHANICAL SCREEN WALL.
- NO PLUMBING VENTS OR EXHAUST UNITS WITHIN 12'-0" OF INTAKE OR 5'-0" OF EXTERIOR WALL.
- ALL ROOF PENETRATIONS, INCLUDING PLUMBING AND ELECTRICAL ROOF JACKS SHALL BE 1" MIN. APART AND MADE PRIOR TO MEMBRANE ROOF INSTALLATION OVERFLOW SCUPPERS SHALL BE 2" ABOVE PRIMARY ROOF DRAIN RIMS.
- COORDINATE AND VERIFY INSTALLATION.
- BACK SIDE OF PARAPETS TO BE FINISHED TO MATCH COLOR OF WALL IN FRONT STUCCO FINISH COAT ON TOP AND BACK SIDES OF ALL WALL COPINGS.
- THE ATTIC SPACE SHALL BE ACCESSIBLE. PROVIDE 20' x 30' ACCESS DOOR AT 6TH FLOOR CEILING. FIRE RATED.
- MULTIPLE ROOF TOP HVAC UNITS ARE TO BE IDENTIFIED INDIVIDUALLY AND BY THE AREA UNIT THEY SERVE.
- FRAMER TO PROVIDE 2M BLOCKING BETWEEN TRUSSES AT EACH ROOF VENT OPENING. DISPERSE ROOF VENTS THROUGHOUT THE ROOF AREA BEING SERVED. DRAFTSTOPPINGS IN ATTICS IS NOT REQUIRED IN GROUP R-2 OCCUPANCIES EQUIPPED WITH AN AUTOMATIC SPRINKLER COMPLYING WITH 903.3.1.1, PER IBC 718.4.2 EXCEPTION 2.


ROOF KEYNOTES

- 1" THICK MIN. CLASS B RIGID SPRAY APPLIED POLYURETHANE FOAM ROOFING SYSTEM WITH CEMENTITIOUS TOP COATING OVER EXTERIOR GRADE PLYWOOD SHEATHING. PER ESR-2532.
MIN. AGED SOLAR REFLECTANCE 0.55
MIN. AGED THERMAL EMITTANCE 0.75
MIN. AGED SRI 60
- STUCCO SYSTEM OVER PLYWOOD SHEATHING
- ROOF EDGE FOAM STOP AND METAL FASCIA
- METAL SCUPPER THROUGH WALL
- AD CONDENSING UNIT - REFER TO MECHANICAL DRAWINGS AND DETAILS
- PARAPET - RUN FOAM UP BACKSIDE OF WALL TO STUCCO
- BUILT-UP FOAM DANT AT PERIMETER OF ROOF - REFER TO DETAIL X1A9.X
- BUILT-UP WOOD FRAME CRICKET - 1/4" SLOPE MIN. - 1/8 CROSS SLOPE MIN AT CRICKET VALLEY
- CANTILEVERED ROOF OVERHANG - FOAM ROOF ON TOP
- ROOF DRAIN AND OVERFLOW (RO&OF) - REFER TO DETAIL X1A9.X
- RUN RO&OF DOWN DEMISING OR CORRIDOR WALL BELOW - THROUGH GARAGE DECK
- RUN RO&OF LEADER DOWN THROUGH DEMISING AND/OR UNIT WALL BELOW TO GROUND FLOOR CEILING
- VENT STACK FOR TRASH CHUTE.
- ROOF VENT TYPICAL - REFER TO ROOF SYMBOLS.

ROOF SYMBOLS LEGEND

- 1/4" FT SLOPE ROOF SLOPE TO DRAIN 1/4" PER FOOT.
- 1/8" FT SLOPE ROOF CRICKET SLOPE TO DRAIN
- ROOF DRAIN AND OVERFLOW - REFER TO DETAIL
- 18" x 18" FLAT VENT CAP - REFER TO DETAIL
- 22 1/2" W x 30" H - WALL LOUVER VENT - REFER TO DETAIL
- ROOF MOUNTED TRASH CHUTE EXHAUST
- 0'-0" HEIGHT OF ELEMENT A.F.F. (0'-0")
- CONDENSING UNITS ON RAISED CURB - REFER TO MECHANICAL

KEYPLAN

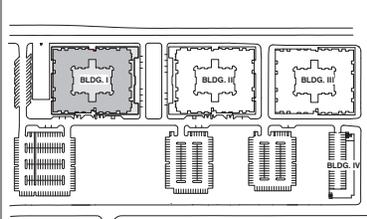

K & J HOMES, LLC
4422 N. DAVIS CENTER PLAZA
SUITE 202
SCOTTSDALE, AZ 85251
PH: 480-970-8800



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KRISTAN
SOURDISON




K. Sourdison

SHEET TITLE:
Bldg I -
Roof Plan

SHEET NUMBER:

A2.8



PAD / DPR #3

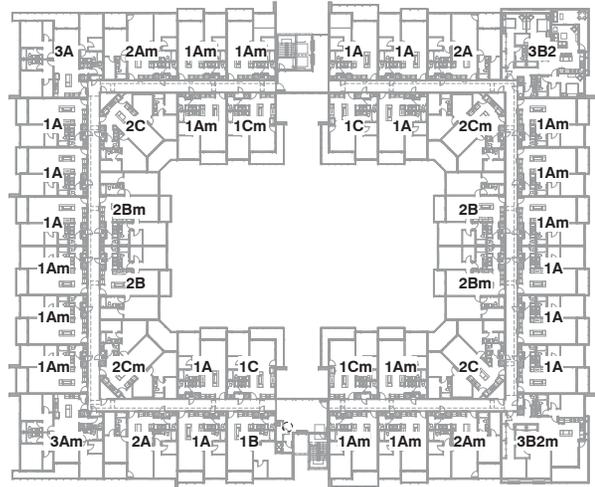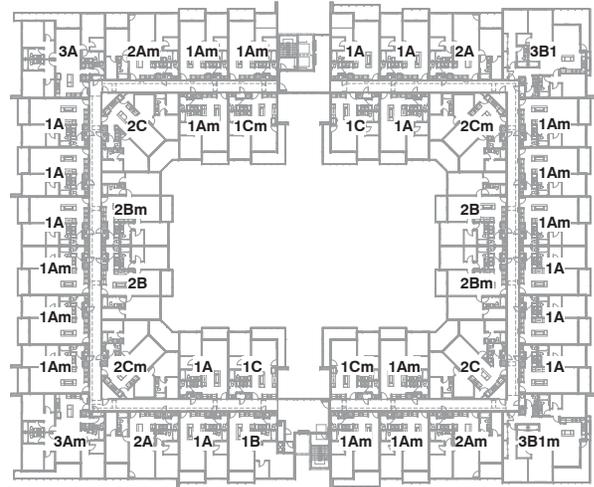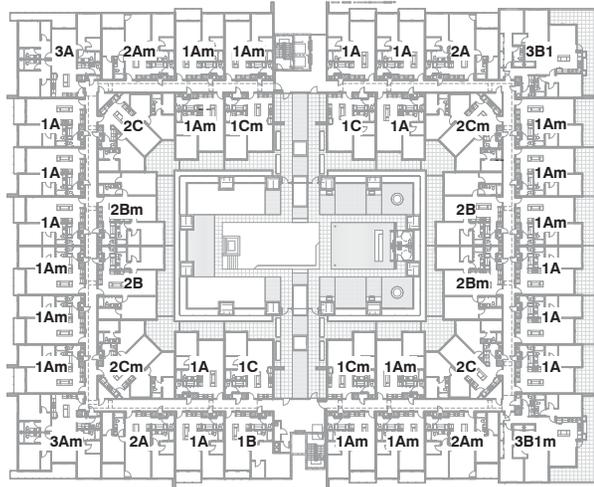

② 2nd Floor - Unit Mix
1" = 30'-0"
m' - Indicates 'mirrored unit'

④ 4th Floor - Unit Mix
1" = 30'-0"
m' - Indicates 'mirrored unit'

⑥ 6th Floor - Unit Mix
1" = 30'-0"
m' - Indicates 'mirrored unit'

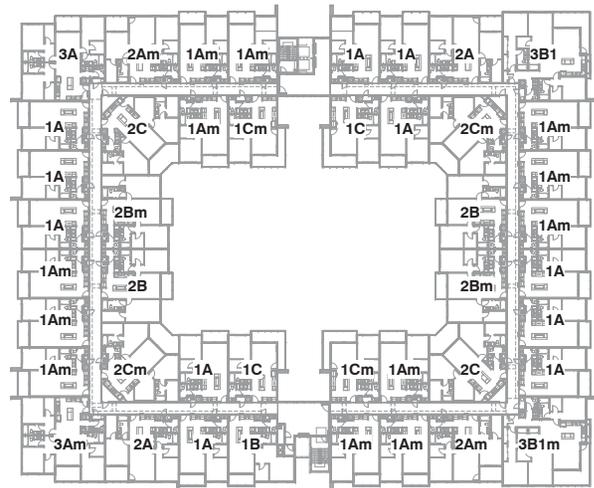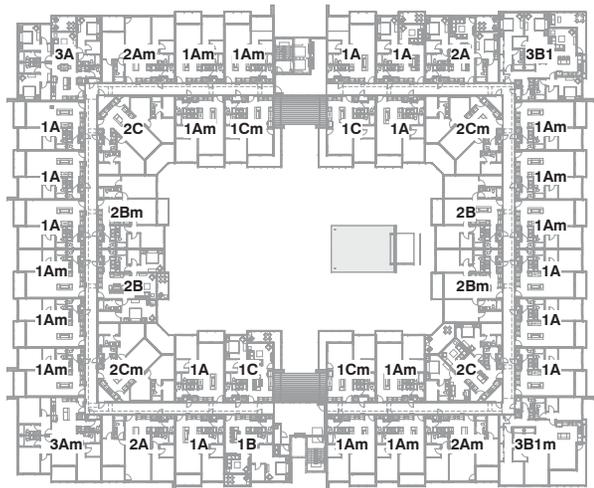

③ 3rd Floor - Unit Mix
1" = 30'-0"
m' - Indicates 'mirrored unit'

⑤ 5th Floor - Unit Mix
1" = 30'-0"
m' - Indicates 'mirrored unit'

EASTLINE VILLAGE Unit Mix & Gross Rentable Areas 6/13/2016																
Unit	Type	Gross Areas		Units per Building - Bldg 1						220 Total Units	Total Gross Area/Unit	Total	Total % of total	Total Beds		
		Unit	Balcony/Total	2nd Flr	3rd Flr	4th Flr	5th Flr	6th Flr	Units							
1A	1 Bed	536	81	1,017	23	23	23	23	23	116	36,143	31,113	108,455	140	63.64	140
1B	1 Bed	564	81	1,048	1	1	1	1	1	5	1,641	408	3,249	60	27.27	120
1C	1 Bed	543	154	1,057	4	4	4	4	4	20	16,863	3,283	20,146			
2A	2 Bed	1,220	93	1,313	4	4	4	4	4	20	24,783	1,360	26,143			
2B	2 Bed	1,232	92	1,324	4	4	4	4	4	20	24,842	1,442	26,284			
2C	2 Bed	1,382	168	1,550	4	4	4	4	4	20	27,841	3,323	30,964			
3A	3 Bed	1,899	152	2,051	2	2	2	2	2	10	18,540	1,200	19,740			
3B1	3 Bed	1,728	222	1,950	2	2	2	2	2	8	13,924	1,718	15,642			
3B2	3 Bed	1,688	225	1,913	2	2	2	2	2	8	13,376	462	3,838			
Total					44	44	44	44	44	220	228,784	33,048	261,832			

EASTLINE VILLAGE Unit Mix & Net Livable Areas 6/13/2016							
Unit	Type	Average Gross Areas		220 Total Units	Total N.L.A.	Total	Total % of total
		Unit	Balcony/Total				
1A	1 Bed	542	150	116	66,232	140	63.64
1B	1 Bed	1,384	114	5	4,230	60	27.27
1C	1 Bed	1,053	152	20	15,480		
2A	2 Bed	1,312	93	20	25,240		
2B	2 Bed	1,324	92	20	25,220		
2C	2 Bed	1,550	168	20	30,000		
3A	3 Bed	1,960	152	10	18,600		
3B1	3 Bed	1,841	222	8	13,128		
3B2	3 Bed	1,591	225	8	3,184		
Total				220	213,440		

EASTLINE VILLAGE Unit Mix & Net Livable Areas 6/13/2016													
Unit	Type	Average Gross Areas		Units per Building - Bldg 1						220 Total Units	Total N.L.A.	Total	Total % of total
		Unit	Balcony/Total	2nd Flr	3rd Flr	4th Flr	5th Flr	6th Flr	Units				
1A	1 Bed	542	150	23	23	23	23	23	116	66,232	140	63.64	
1B	1 Bed	1,384	114	1	1	1	1	1	5	4,230	60	27.27	
1C	1 Bed	1,053	152	4	4	4	4	4	20	15,480			
2A	2 Bed	1,312	93	4	4	4	4	4	20	25,240			
2B	2 Bed	1,324	92	4	4	4	4	4	20	25,220			
2C	2 Bed	1,550	168	4	4	4	4	4	20	30,000			
3A	3 Bed	1,960	152	2	2	2	2	2	10	18,600			
3B1	3 Bed	1,841	222	2	2	2	2	2	8	13,128			
3B2	3 Bed	1,591	225	2	2	2	2	2	8	3,184			
Total				44	44	44	44	44	220	213,440			

K & J HOMES, LLC
4422 N. GAVO CENTER PLAZA
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SCOTTSDALE, AZ 85261
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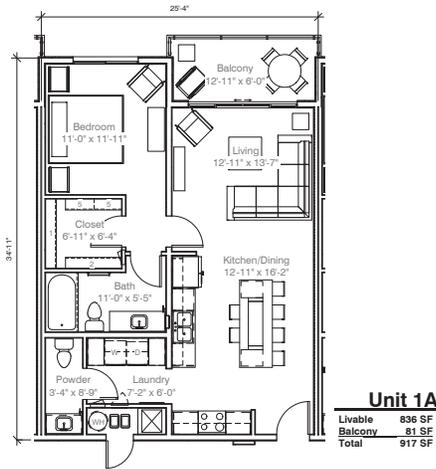
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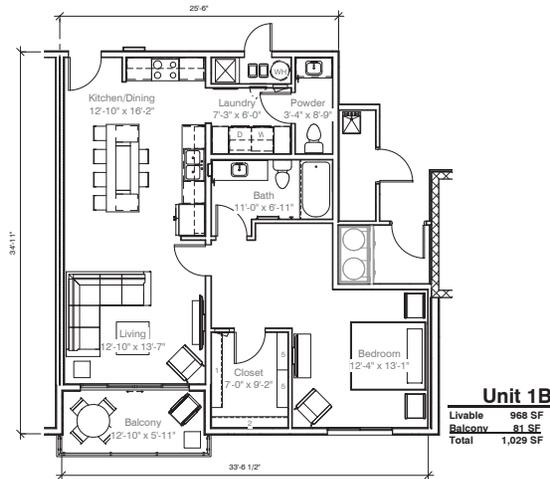
SHEET TITLE:
Unit Mix & Areas - Bldg 1
SHEET NUMBER:

A4.0.1


PAD / DPR #3




1 UNIT 1A - FLOOR PLAN
3/16" = 1'-0"




2 UNIT 1B - FLOOR PLAN
3/16" = 1'-0"

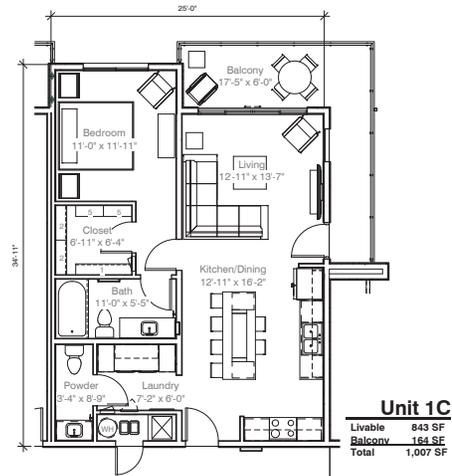


3 UNIT 1C - FLOOR PLAN
3/16" = 1'-0"

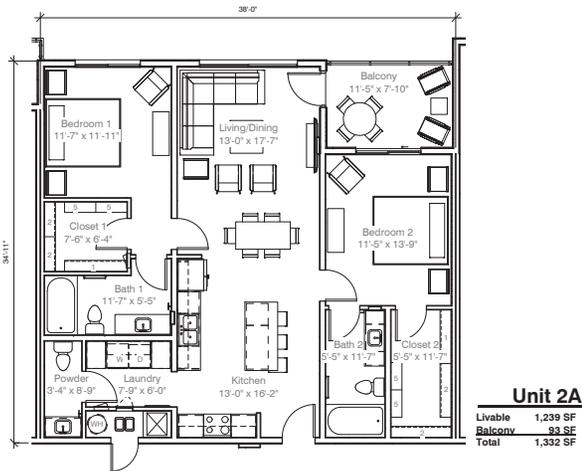

4 UNIT 2A - Floor Plan
3/16" = 1'-0"

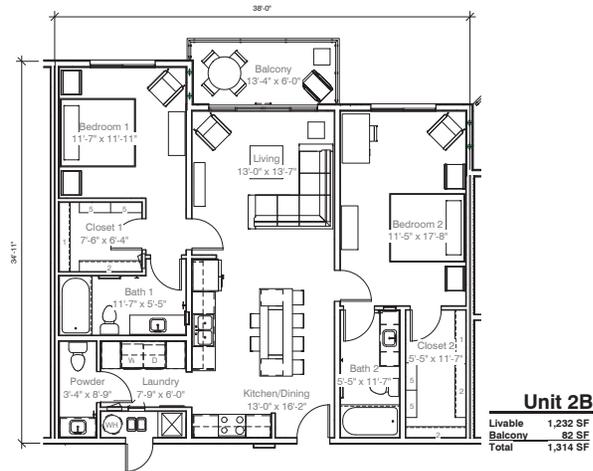

5 UNIT 2B - FLOOR PLAN
3/16" = 1'-0"

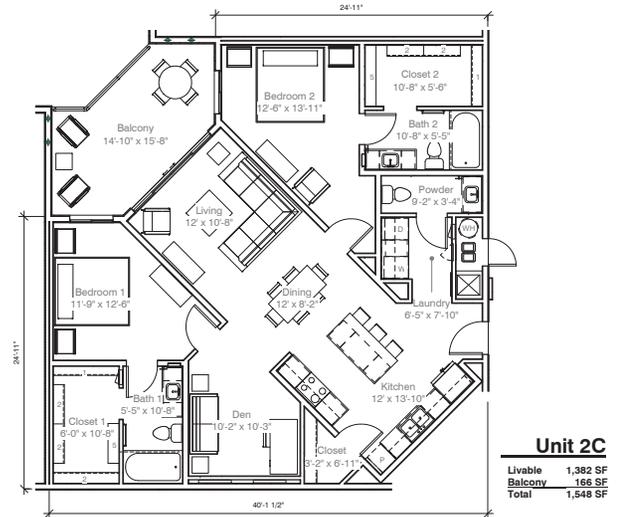

6 UNIT 2C - FLOOR PLAN
3/16" = 1'-0"



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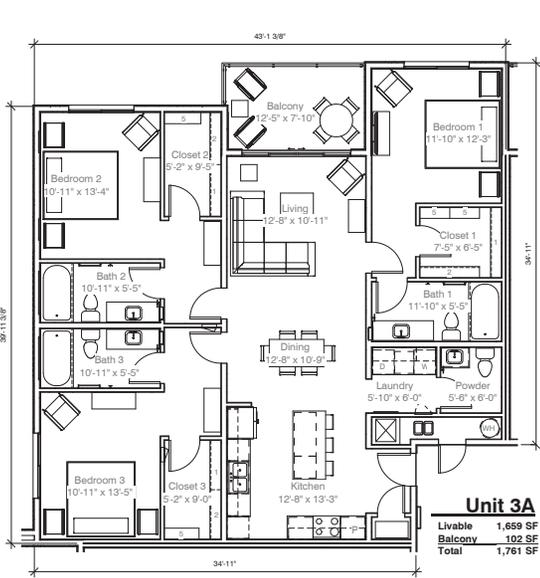
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SHEET TITLE:
 Unit Plans


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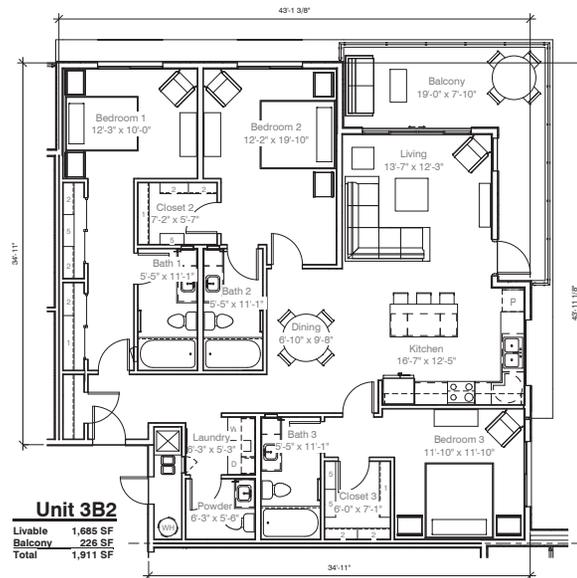
PAD / DPR #3



① UNIT 3A - FLOOR PLAN
3/16" = 1'-0"



② UNIT 3B1 - FLOOR PLAN
3/16" = 1'-0"

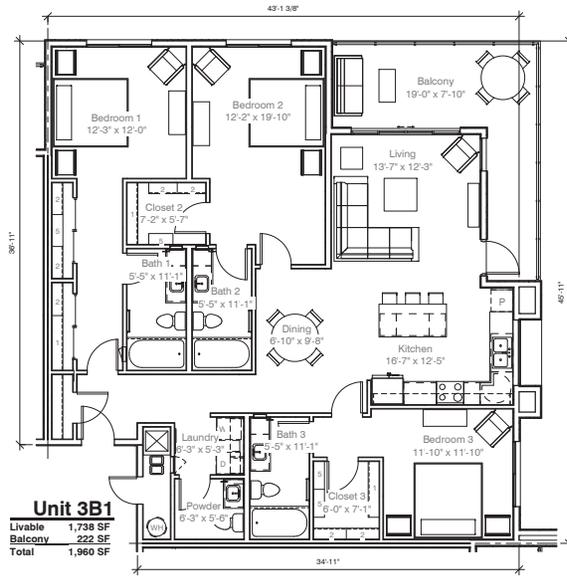

③ UNIT 3B2 - FLOOR PLAN
3/16" = 1'-0"

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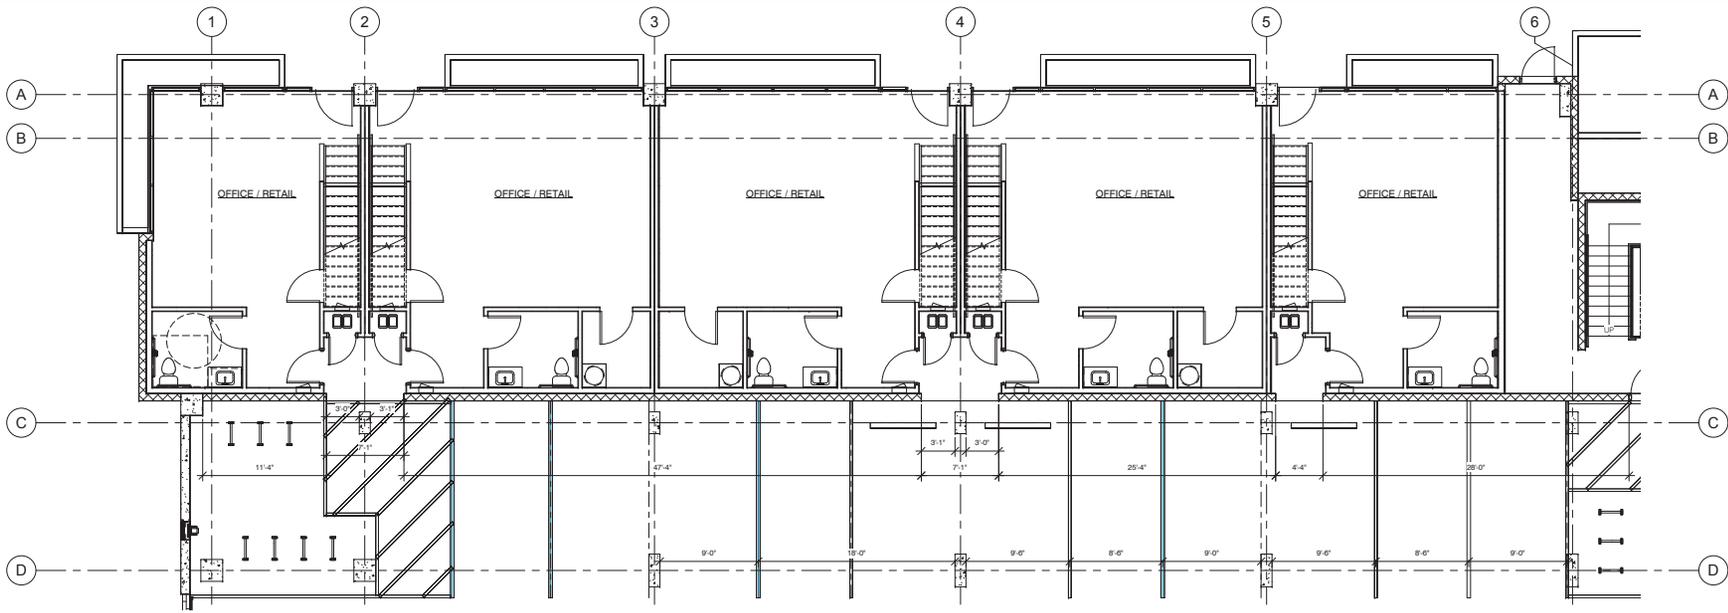
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K. Sourdis
SHEET TITLE:
Unit Plans

SHEET NUMBER:

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1 LW-Units @ P1 Parking / Ground Floor
3/16" = 1'-0"

Unit LW-A

Ground Level 511 SF
Upper Level 688 SF
Total 1,199 SF
Balcony 80 SF

Unit LW-B

Ground Level 692 SF
Upper Level 674 SF
Total 1,366 SF
Balcony 138 SF

Unit LW-C


Ground Level 734 SF
Upper Level 715 SF
Total 1,449 SF
Balcony 148 SF

Unit LW-Cm

Ground Level 734 SF
Upper Level 715 SF
Total 1,449 SF
Balcony 148 SF

Unit LW-D

Ground Level 548 SF
Upper Level 738 SF
Total 1,286 SF
Balcony 119 SF

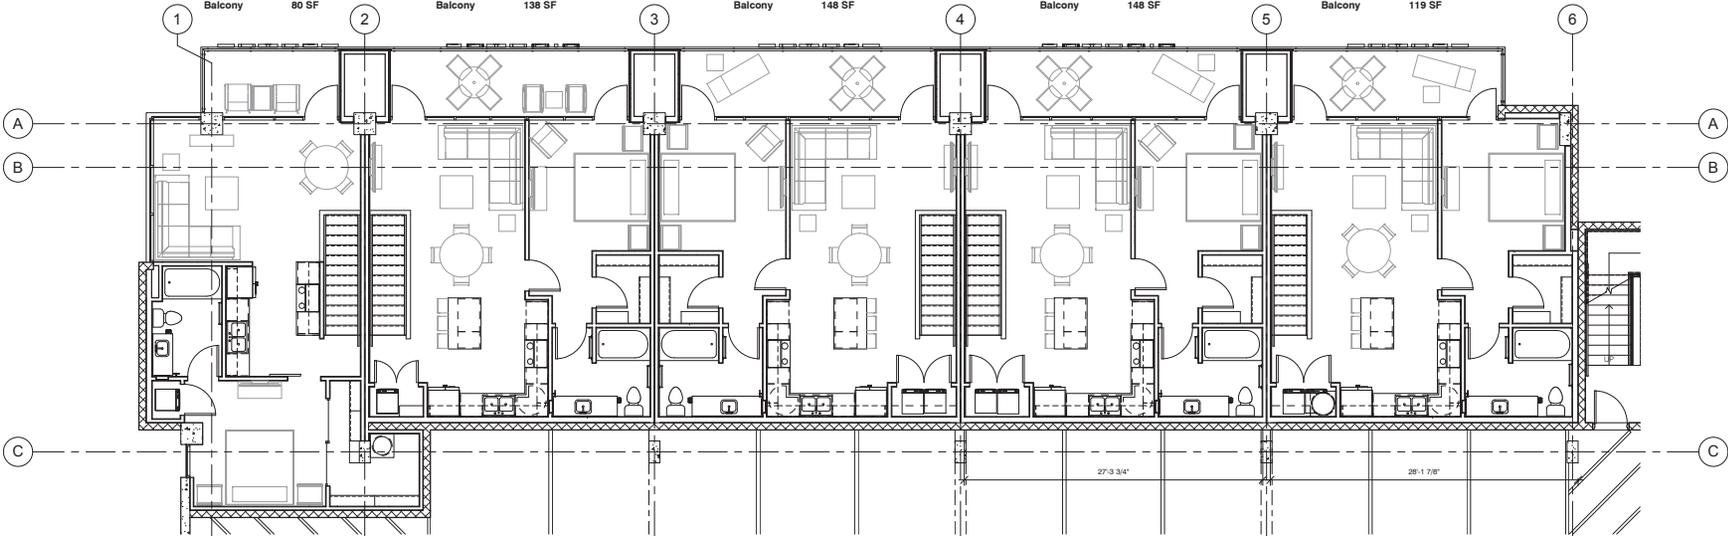

2 LW-Units @ P1 Parking / Upper Level
3/16" = 1'-0"

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SHEET TITLE:
Unit Plans -
LW-Units
SHEET NUMBER:

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PAD / DPR #4



Apache Blvd. from NW

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K. Soussignon
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 Rendering - Apache Blvd. from NW
 SHEET NUMBER:

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PAD / DPR #3



Apache Blvd. from NE

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SHEET TITLE:
 Rendering - Apache Blvd. from NE
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PAD / DPR #3



Typical Balcony



Leasing Office & Main Lobby



Sidewalk along Apache Blvd. Live-Works



Building I - Live-Work Units - from NW

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SHEET TITLE:
 Rendering Vignette

SHEET NUMBER:
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Deck Park

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 Rendering - Deck Park

SHEET NUMBER:
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PUD / DPR #3



① 3D View - Overall Phase I - from NW



② 3D View - Plaza Drive

NOTE: 3D Views shown for massing and character
Landscaping not shown for clarity



③ 3D View - Bldg. 1 - Leasing, Lobby, & Live-Work

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K. Sourson

SHEET TITLE:
 3D Views - Overall Site
 SHEET NUMBER:

A1.8.1

PUD / DPR #3



① 3D View - Overall Phase I - from SE



② 3D View - Plaza Drive - from SE

NOTE: 3D Views shown for massing and character
Landscaping not shown for clarity




③ 3D View - Bldg. II - Garage Entry

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SHEET TITLE: 3D Views - Overall Site		
SHEET NUMBER: A1.8.2		
PUD / DPR #3		



① 3D View - Plaza Area - from 2nd floor above

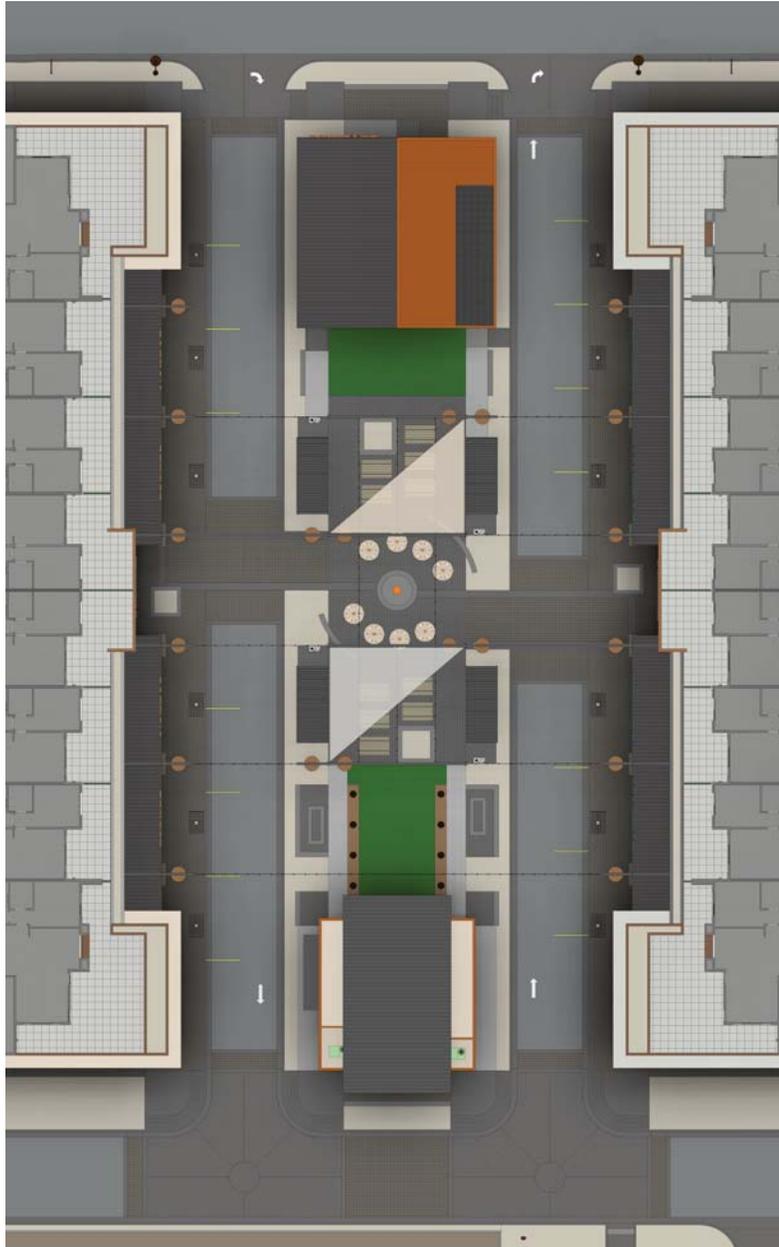

② 3D View - Plaza Area - from NW

NOTE: 3D Views shown for massing and character
Landscaping not shown for clarity



③ 3D View - Plaza Area - from SE

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SHEET TITLE:
3D Views - Plaza

SHEET NUMBER:

A1.8.3

PAD / DPR #3



3D View - Bldg. II Main Lobby at Apache Blvd.



Bldg. II - Garage Wall on East side - without Landscaping



Bldg. II - Garage Wall on East side - with Landscaping



3D View - Bldg. II Ground Floor at NEC



3D View - Bldg I Ground Floor at NEC



3D View - Bldg. I - Main Lobby off Apache Blvd.



3D View - Bldg. I Ground floor at NWC

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 DESIGN MANAGEMENT
 BUREAU


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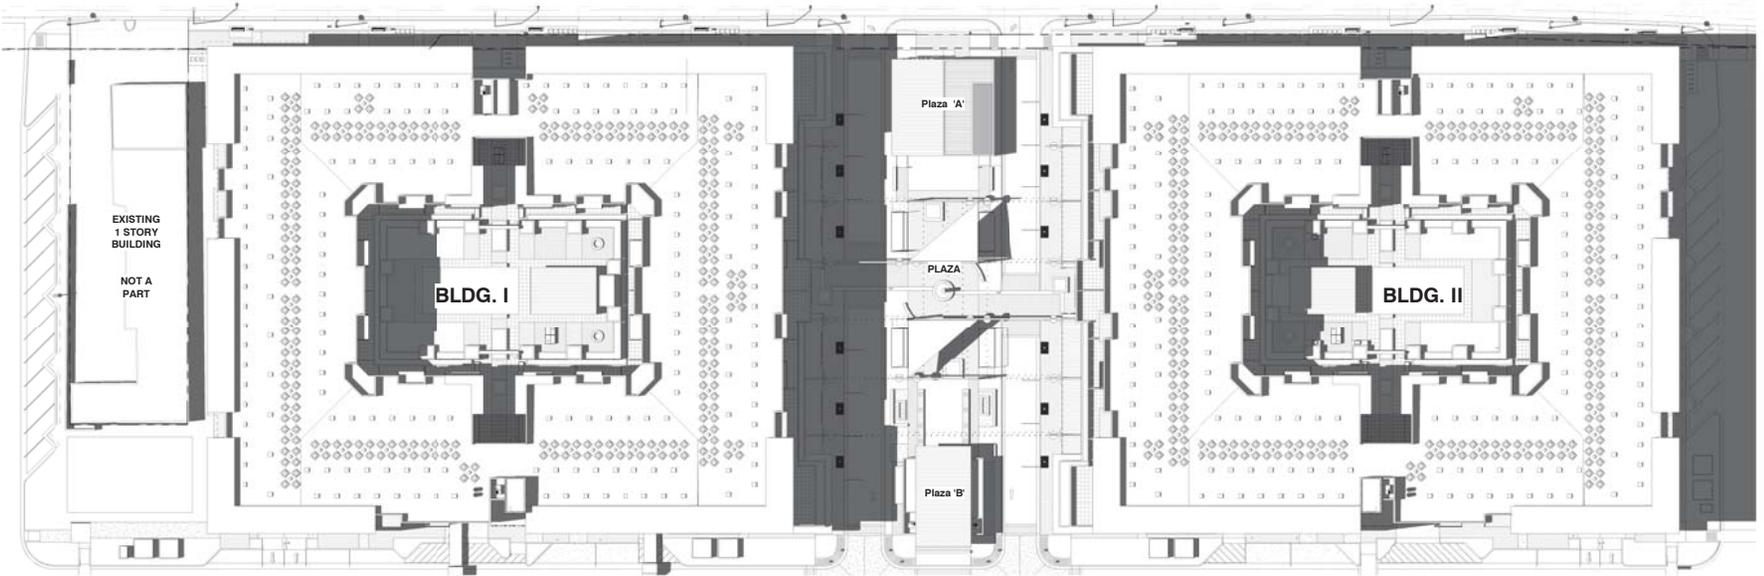
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K. Souris
 SHEET TITLE:
 3D Views - Vignette
 SHEET NUMBER:
A1.8.4
 PAD / DPR #3



① PHASE I - DEVELOPMENT SHADOW STUDY - GROUND LEVEL @ 3pm ON SUMMER SOLSTICE (SHOWING SHADE FROM BUILDING ELEMENTS ABOVE)
1" = 30'-0"

NOTE: SHADED AREA SHOWN DOES NOT INCLUDE SHADE PROVIDED BY TREES ALONG ALL SIDEWALKS

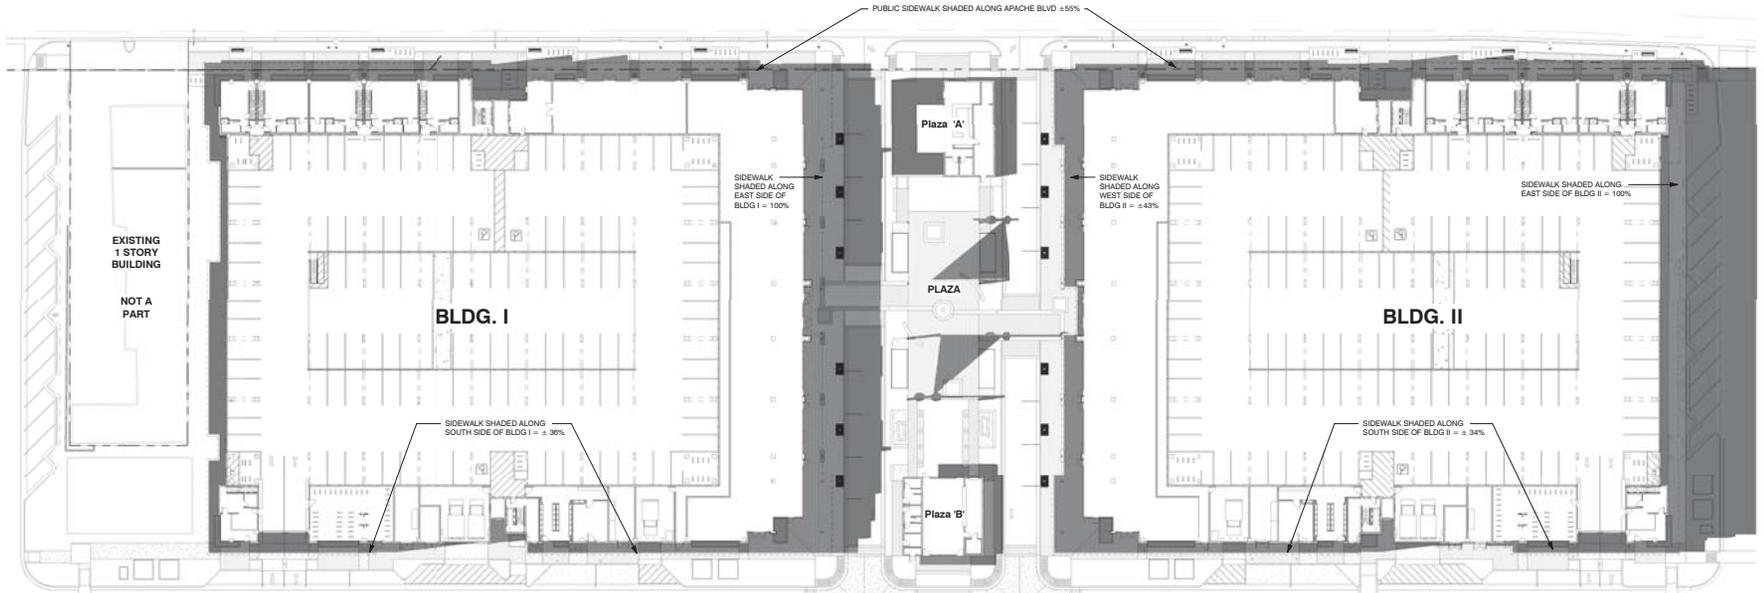

② PHASE I - DEVELOPMENT SHADOW STUDY - ROOF LEVEL @ 3pm ON SUMMER SOLSTICE
1" = 30'-0"



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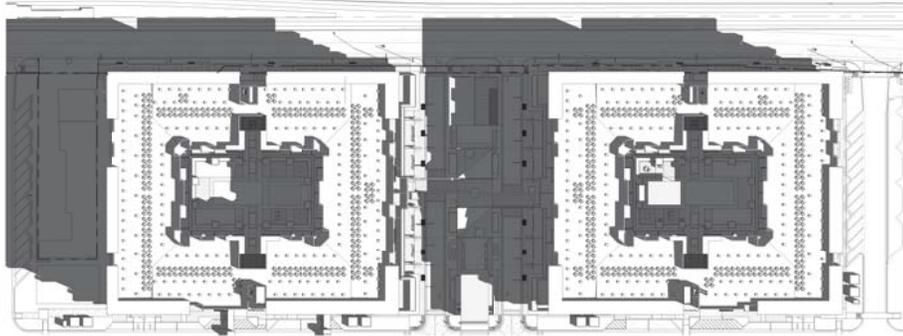
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SHEET TITLE:
Development Shadow Study


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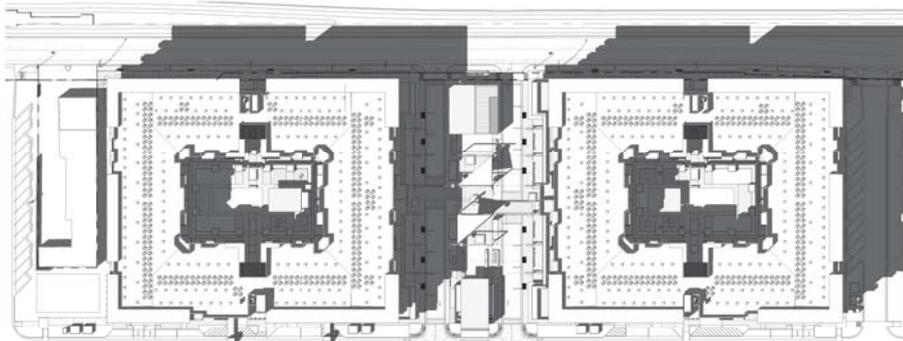
PAD / DPR #3




① PHASE I - VERNAL EQUINOX - MARCH 20th @ 9am
1" = 60'-0"



② PHASE I - VERNAL EQUINOX - MARCH 20th @ 12pm
1" = 60'-0"

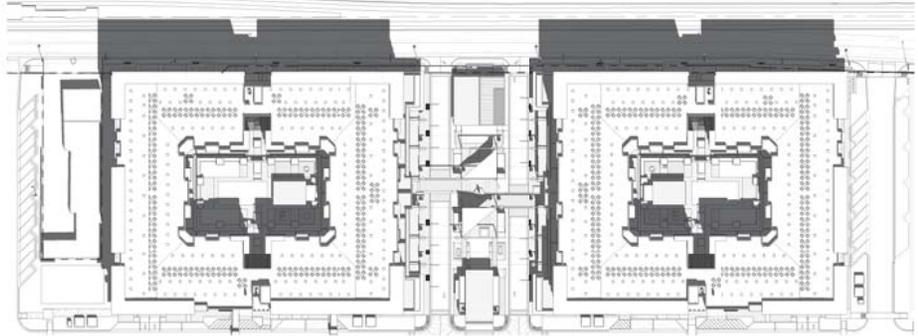

③ PHASE I - VERNAL EQUINOX - MARCH 20th @ 3pm
1" = 60'-0"

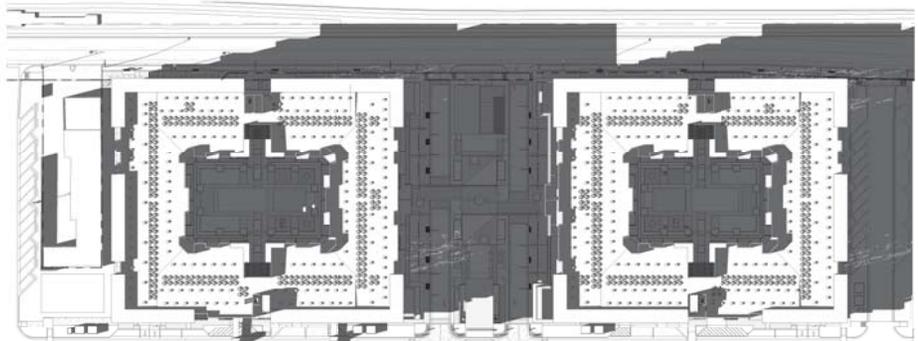

④ PHASE I - VERNAL EQUINOX - MARCH 20th @ 5pm
1" = 60'-0"



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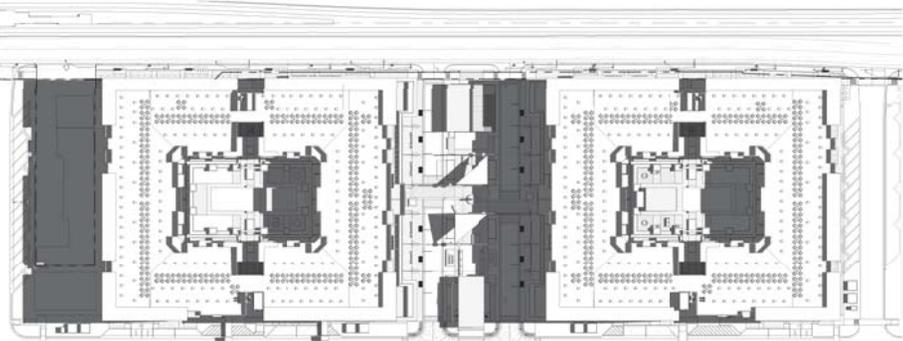
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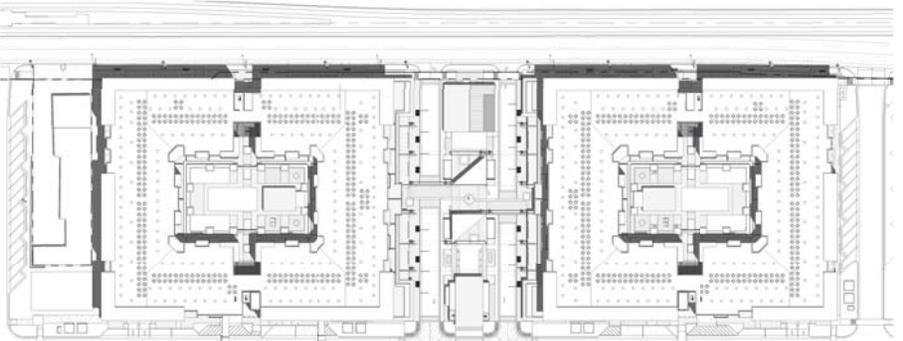
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SHEET TITLE:
Solar Study -
Vernal Equinox
SHEET NUMBER:

A1.7.1


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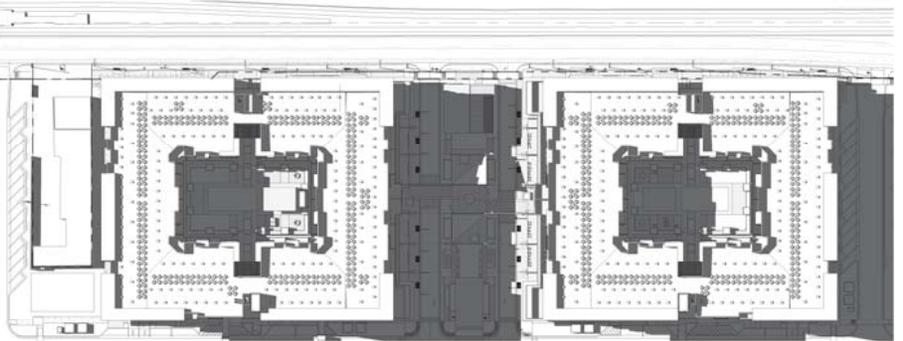
① PHASE I - SUMMER SOLSTICE - JUNE 20th @ 9am
1" = 60'-0"



② PHASE I - SUMMER SOLSTICE - JUNE 20th @ 12pm
1" = 60'-0"



③ PHASE I - SUMMER SOLSTICE - JUNE 20th @ 3pm
1" = 60'-0"

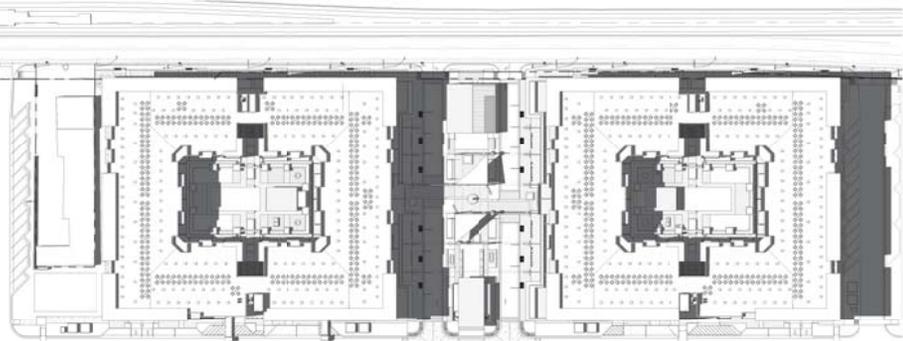

④ PHASE I - SUMMER SOLSTICE - JUNE 20th @ 5pm
1" = 60'-0"



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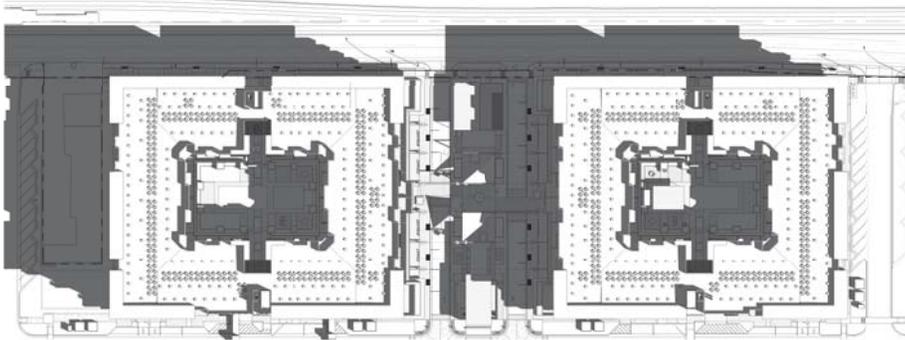
3287
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SOURDISON
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SHEET TITLE:
Solar Study -
Summer Solstice


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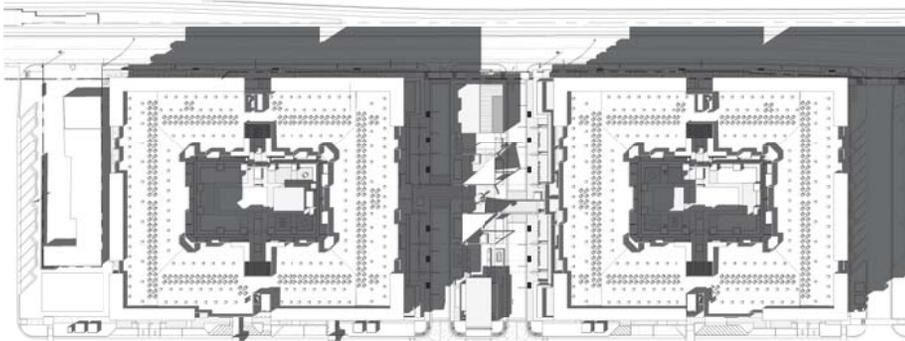
PAD / DPR #3




① PHASE I - AUTUMNAL EQUINOX - SEPTEMBER 22th @ 9am
1" = 60'-0"



② PHASE I - AUTUMNAL EQUINOX - SEPTEMBER 22th @ 12pm
1" = 60'-0"

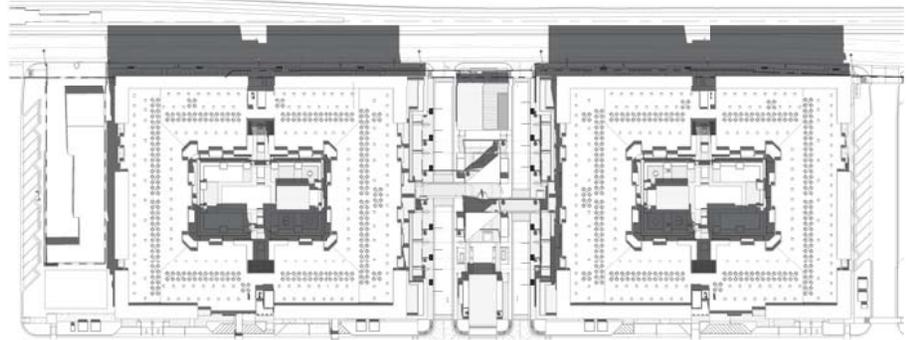

③ PHASE I - AUTUMNAL EQUINOX - SEPTEMBER 22th @ 3pm
1" = 60'-0"

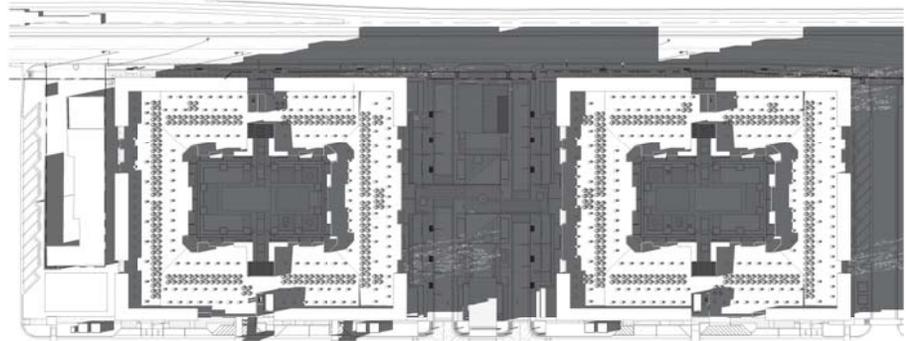

④ PHASE I - AUTUMNAL EQUINOX - SEPTEMBER 22th @ 5pm
1" = 60'-0"



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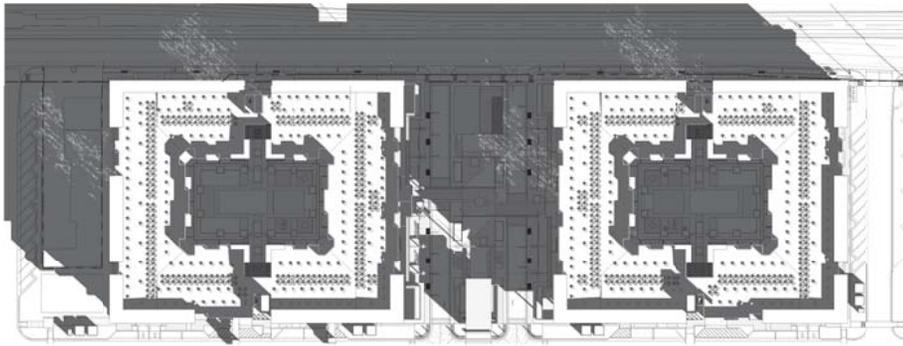
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#	Description	Date
OWNERSHIP OF DOCUMENTS		
DRAWINGS AND SPECIFICATIONS AS INSTRUMENTS OF SERVICE ARE AND SHALL REMAIN THE PROPERTY OF THE ARCHITECT UNLESS THE PROJECT FOR WHICH THEY WERE PREPARED IS TO BE USED ON OTHER PROJECTS OR BY AGREEMENT IN WRITING AND WITH APPROPRIATE COMPENSATION TO K & J HOMES, LLC.		
JOB NUMBER:		
DRAWN BY: AD		
CHECKED BY: KS		
ISSUE DATE: 06/22/2016		




SHEET TITLE:
Solar Study -
Autumnal Equinox
SHEET NUMBER:

A1.7.3


PAD / DPR #3




1 PHASE I - WINTER SOLSTICE - DECEMBER 21st @ 9am
1" = 60'-0"

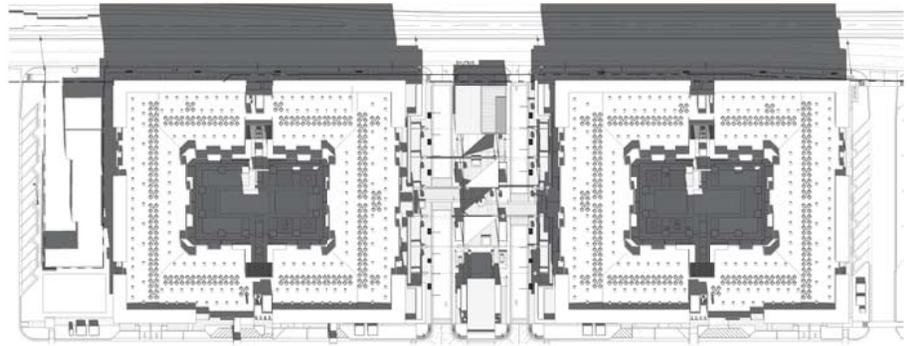

2 PHASE I - WINTER SOLSTICE - DECEMBER 21st @ 12pm
1" = 60'-0"

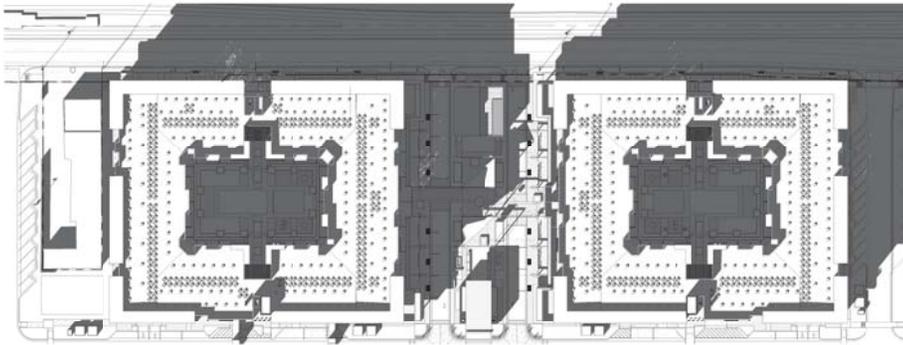

3 PHASE I - WINTER SOLSTICE - DECEMBER 21st @ 3pm
1" = 60'-0"

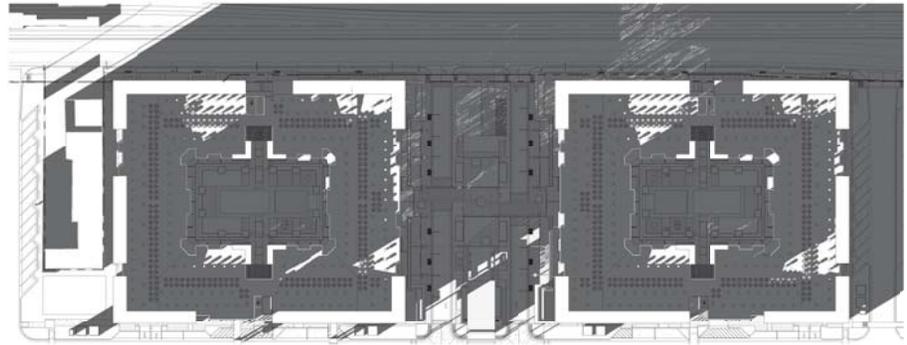

4 PHASE I - WINTER SOLSTICE - DECEMBER 21st @ 5pm
1" = 60'-0"



K & J HOMES, LLC
4422 N. GAVO CENTER PLAZA
SUITE 202
SCOTTSDALE, AZ 85251
PH: 480-970-8800



uhdc
URBAN HOME
DEVELOPMENT
CORPORATION



VILLAGE EASTLINE
LIVE - WORK - PLAY
APACHE BLVD. REDEVELOPMENT
TEMPE, ARIZONA

Revisions		
#	Description	Date
OWNERSHIP OF DOCUMENTS		
DRAWINGS AND SPECIFICATIONS AS INSTRUMENTS OF SERVICE ARE AND SHALL REMAIN THE PROPERTY OF THE ARCHITECT. WHETHER THE PROJECT FOR WHICH THEY WERE PREPARED, IS TO BE USED ON OTHER PROJECTS OR NOT, THEY ARE NOT TO BE REPRODUCED OR TRANSMITTED IN ANY FORM OR BY ANY MEANS, ELECTRONIC OR MECHANICAL, INCLUDING PHOTOCOPYING, RECORDING, OR BY ANY INFORMATION STORAGE AND RETRIEVAL SYSTEM, WITHOUT THE WRITTEN PERMISSION OF THE ARCHITECT.		
JOB NUMBER:		
DRAWN BY: AD		
CHECKED BY: KS		
ISSUE DATE: 06/22/2016		




SHEET TITLE:
Solar Study -
Winter Solstice

SHEET NUMBER:
A1.7.4

PAD / DPR #3

Exhibit A: Site and Surrounding Uses

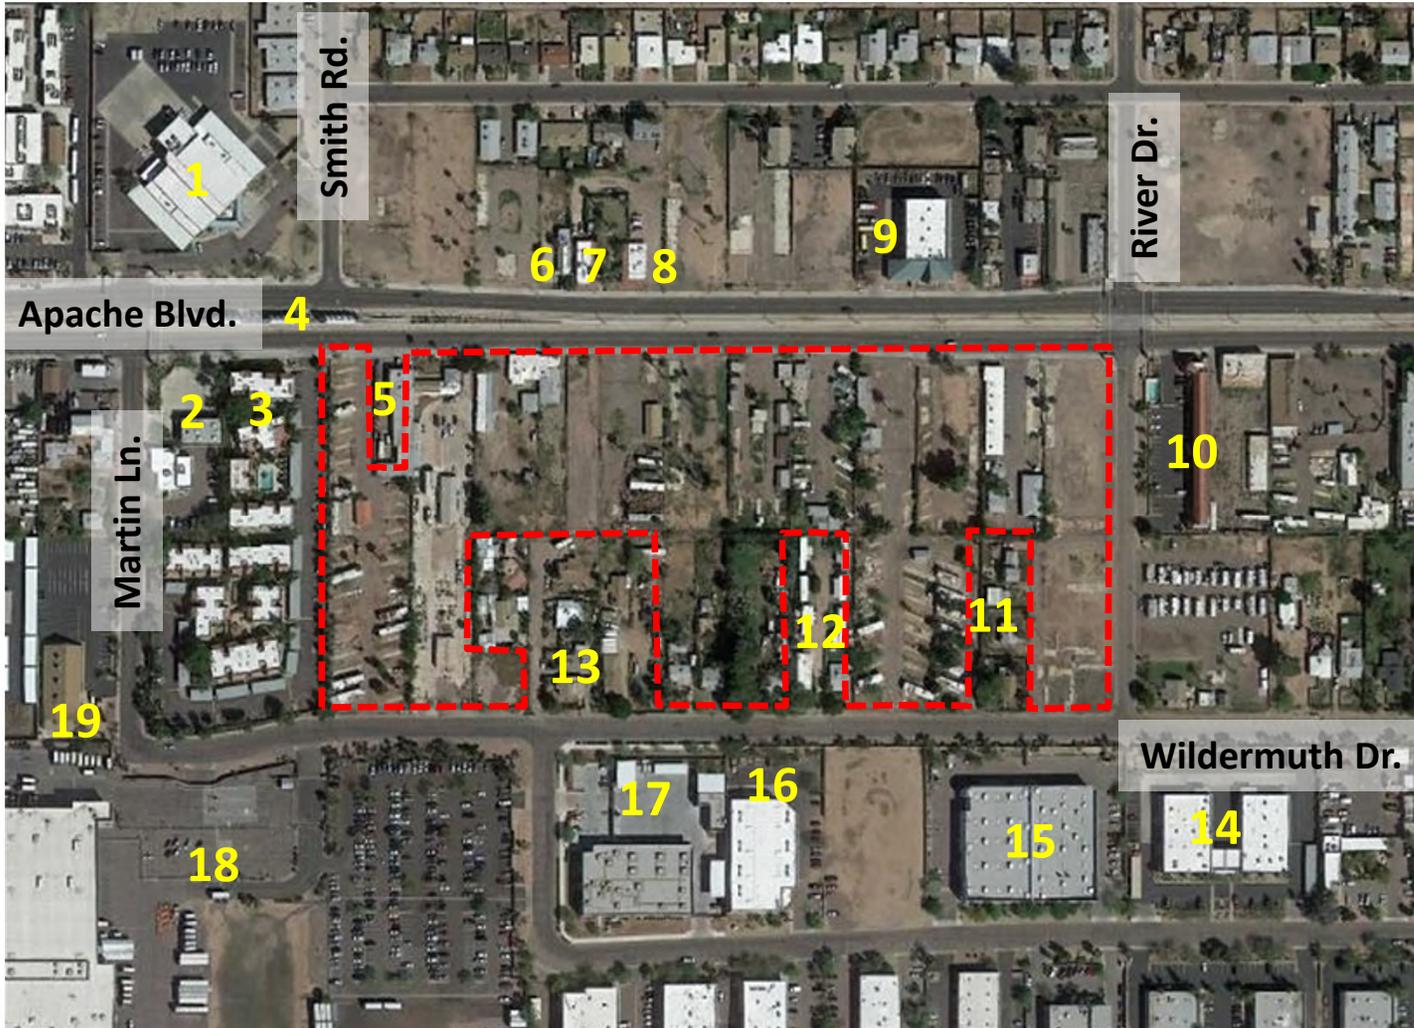


1. U.S. Post Office
2. Persepolis Auto
3. La Paloma Apartments
4. Apache/Smith LRT Station #26
5. Hopper's Automotive
6. Palm Reader Tarot Cards
7. Residential Triplex
8. Residential Fourplex
9. American Five Star Transmission
10. Rodeway Inn
11. Single family homes
12. Drago Estates mobile home park
13. Single family homes
14. Alliance Fire Protection Co.
15. All Wood Treasures Furniture
16. U.S. Industrial Fastener of Arizona
17. City of Tempe Fire Department Support Services
18. UPS Customer Center
19. Evangelical Fomosan Church



Eastline Village

EAST LINE: SITE CONTEXT PHOTO EXHIBIT

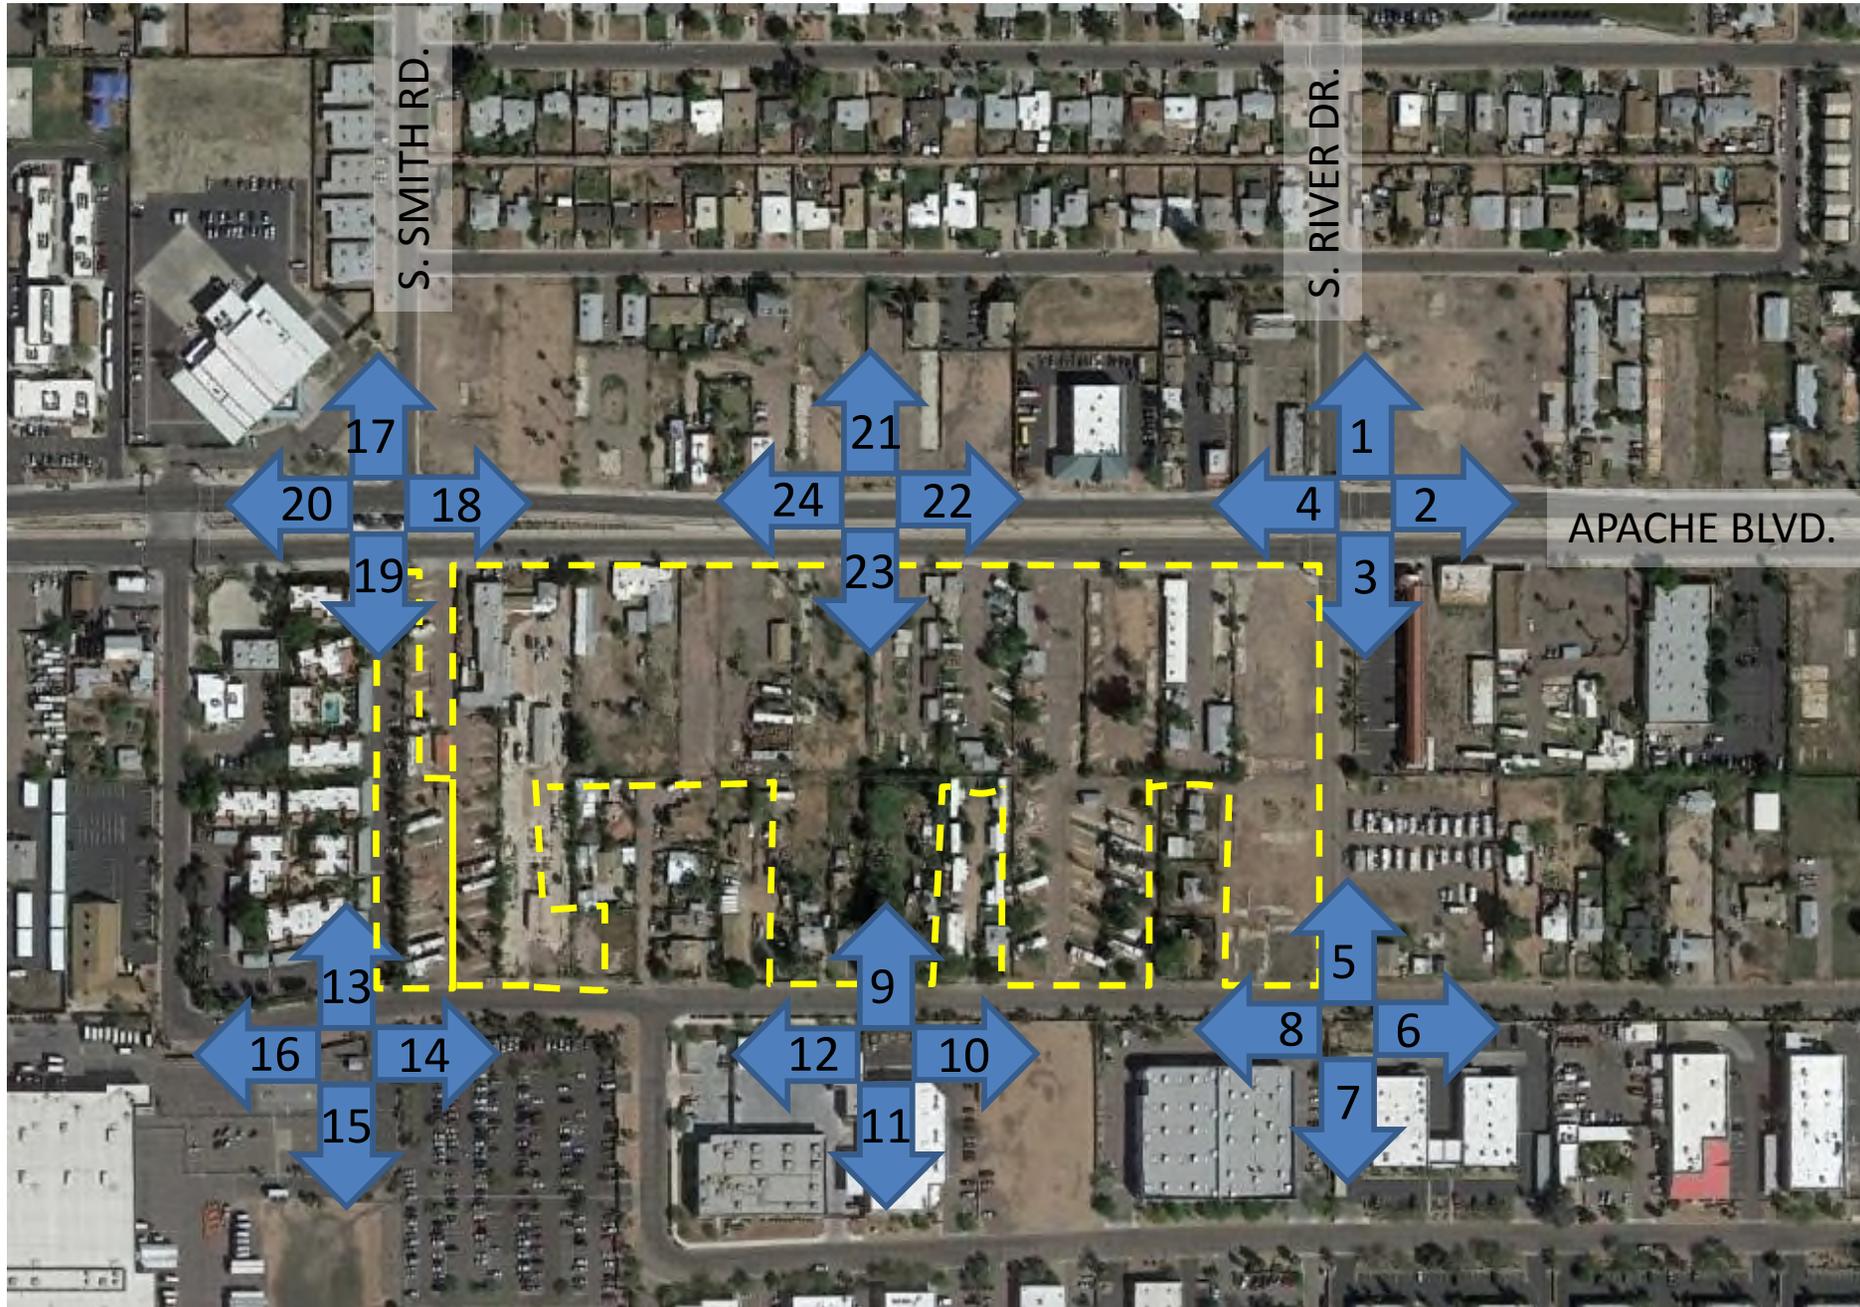



1. NEC facing north



2. NEC facing east



3. NEC facing south



4. NEC facing west



5. SEC facing north



6. SEC facing east



7. SEC facing south



8. SEC facing west



9. Mid-block Wildermuth facing north



10. Mid-block Wildermuth facing east



11. Mid-block Wildermuth facing south



12. Mid-block Wildermuth facing west



13. SWC facing north



14. SWC facing east



15. SWC facing south



ATTACHMENT 76 16. SWC facing west



17. NWC facing north



18. NWC facing east



19. NWC facing south



20. NWC facing west



21. Mid-block Apache facing north




22. Mid-block Apache facing east



23. Mid-block Apache facing south



24. Mid-block Apache facing west

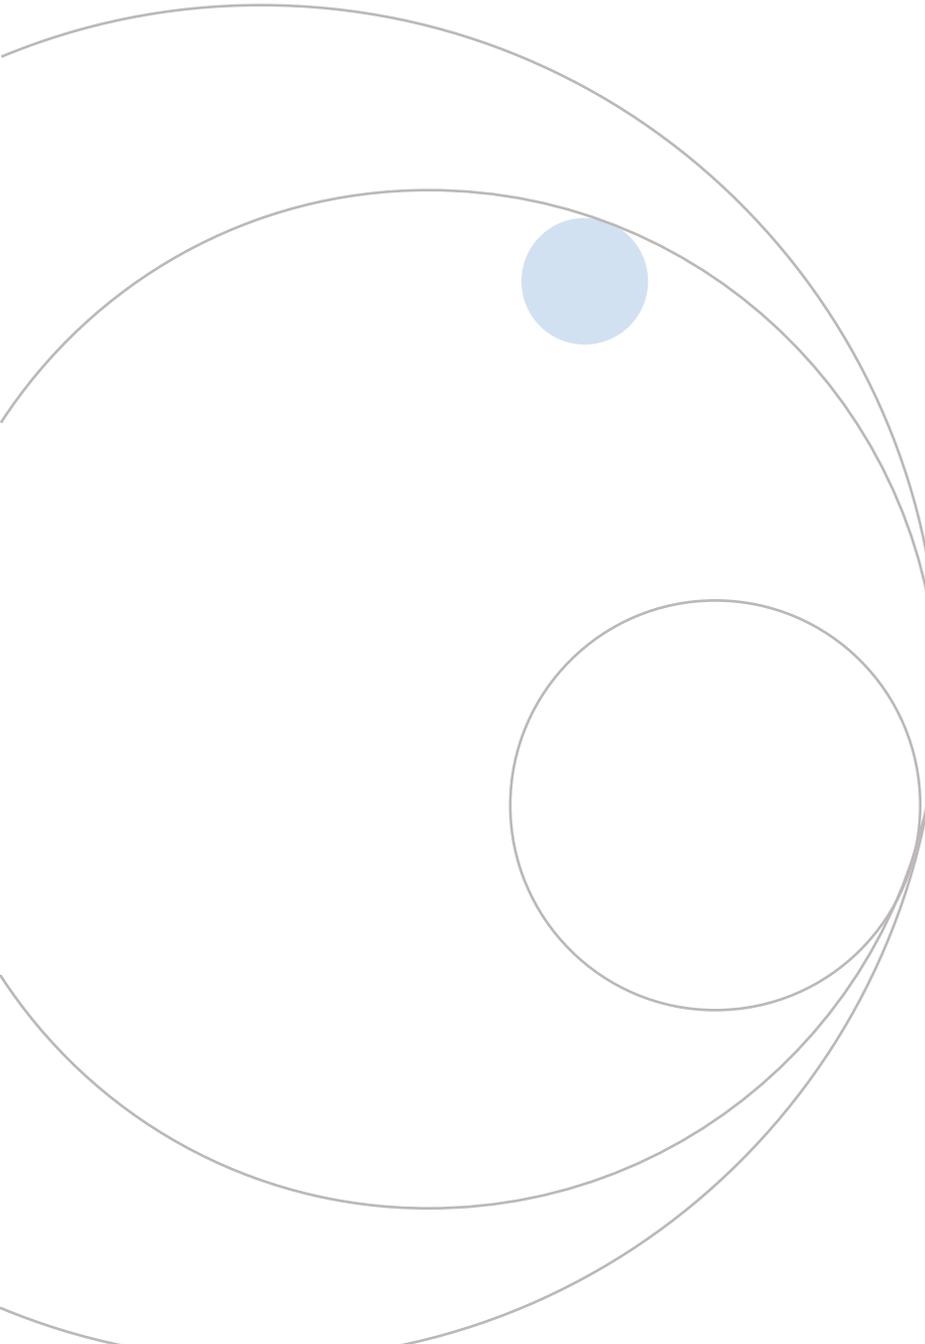

Eastline Village

Traffic Impact Study

Southeast Corner of River Drive
and Apache Boulevard
in Tempe, Arizona

March 2016
Project No. 16-0160

Prepared For:
K&I Homes
4422 N. Civic Center Plaza
Scottsdale, Arizona 85251

For Submittal to:
City of Tempe

Prepared By:



10605 North Hayden Road
Suite 140
Scottsdale, Arizona 85260
480-659-4250

EXECUTIVE SUMMARY

This report documents a traffic impact study prepared for the proposed EASTLINE Village development to be located in the southwest corner of River Drive and Apache Boulevard in the City of Tempe, Arizona. The project is proposed in two (2) phases. The first phase will develop two buildings inclusive of a bar, restaurant, gym/yoga studio, office/retail space, and apartments. The second phase will develop a third and fourth building, adding additional office/retail space and apartments. CivTech Inc. has been retained to complete a traffic impact study for the proposed development during the planning process.

The purpose of this study is to address traffic and transportation impacts of the proposed development on the surrounding streets and intersections. This was prepared to standard criteria set forth by the City of Tempe in their *Guide for the Preparation of Transportation Impact Studies, updated 05/2014*. The specific objectives of the study are:

1. Evaluate lane requirements on all existing roadways and at all existing intersections within the study area.
2. Determine future level of service for all proposed major intersections within the study area and recommend any capacity related improvements.
3. Determine necessary lane configurations at all major intersections within the proposed development to provide acceptable future levels of service.
4. Evaluate the need for future traffic control changes within the proposed study area.
5. Evaluate the need for auxiliary lanes at stop and signal controlled intersections.

This study evaluates the existing year (2016), Phase I opening year (2017), and Phase II opening year (2025).

The following conclusions and recommendations have been documented in this study:

General

- As shown in **Table 3**, the existing study intersections operate at an acceptable level of service (LOS D or better), with the exception of the intersections of **McClintock Drive and Apache Boulevard**, under the existing lane configurations and stop control shown in **Figure 2**.
- The intersection of **McClintock Drive and Apache Boulevard** experiences an unacceptable level of service in the westbound approach during the AM peak hour as well as the eastbound approach during the PM peak hour. In its existing condition, the delay in the eastbound approach in both peak hours is around 60-seconds.
- Construction of Eastline Village will be analyzed in two (2) phases. Phase I will assume the completion of Buildings I and II in the opening year 2017. Phase II will assume the full build-out of the development with the completion of Buildings III and IV in horizon year 2025.

Opening Year 2017

- By Phase I completion, the development is anticipated to generate 3,803 weekday daily external trips with 299 occurring in the AM peak hour and 360 occurring in the PM peak hour.
- As shown in **Table 7**, the 2017 Synchro analysis results reveal that all study intersections will operate at an acceptable level of service (LOS D or better), with the exception of the intersections of **McClintock Drive and Apache Boulevard**, under the proposed lane configurations and stop control shown in **Figure 12**. As analyzed in the existing intersection conditions, this intersection experiences unacceptable levels of service in the westbound approach during the AM peak hour as well as the eastbound approach during the PM peak hour.

Horizon Year 2025

- Upon Phase II completion, the development is anticipated to generate 5,267 weekday daily external trips with 425 trips occurring in the AM peak hour and 506 trips occurring in the PM peak hour.
- As shown in **Table 8**, the 2025 Synchro analysis results reveal that all study intersections will continue to operate at acceptable levels of service, with the exception of the intersections of **McClintock Drive and Apache Boulevard**, **River Drive and Apache Boulevard**, and **SB Price Road and Apache Boulevard**.
- Without the addition of site traffic, the intersection of **McClintock Drive and Apache Boulevard** is expected to achieve poor levels of service in the westbound approach during the AM peak hour as well as the southbound and eastbound approaches in the PM peak hour. The addition of site traffic is anticipated to create a poor level of service in the westbound approach during the PM peak hour.
- The intersection of **River Drive and Apache Boulevard** is expected to achieve a poor level of service in the westbound approach during the PM peak hour. The addition of site traffic creates a large number of westbound left-turns at this intersection. The delay for a vehicle making a westbound left-turn is about 185-seconds.
- The intersection of **SB Price Road and Apache Boulevard** is expected to achieve a LOS “E” in the eastbound approach during the PM peak hour. The addition of site traffic is anticipated to create an eastbound delay of about 62-seconds.
- As shown in **Table 9**, all problematic intersections were able to be mitigated to acceptable levels of service, with the exception of the intersection of **McClintock Drive and Apache Boulevard**. As a major intersection in the City of Tempe with restrictions due to the light-rail, a suitable mitigation for this intersection could not be established. As an intersection that currently experiences poor levels of service, it is the responsibility of the City to mitigate this issue.
- Right-turn deceleration lanes are not warranted at any proposed access points. The driveways on Apache Boulevard do not meet the threshold right-turn volume of 40

vehicles per hour (vph). Due to the minimal through volumes and 25 mph speed limit on River Drive, a right-turn deceleration lane is not required at Access E.

- Queue storage lengths for the 2025 build-out year are shown in **Table 10**. It should be noted that the large number of vehicles anticipated to make a westbound left-turn at the intersection of River Drive and Apache Boulevard are anticipated to spill back onto Apache Boulevard. Analysis for the 2017 interim resulted in a recommended queue storage of 275 feet for this turning movement. Additional storage length calculations should be completed prior to a change in intersection stop control.
- Existing sight distance was not measured at the site access points. The contractor should ensure that adequate sight distance is provided at the intersections to allow safe left and right turning movements from the development. Landscaping should be maintained at a maximum of three feet in height. Tree branches lower than seven feet should be trimmed to meet current acceptable landscape requirements while maintaining sight distance.

GAMMAGE & BURNHAM

A PROFESSIONAL LIMITED LIABILITY COMPANY

ATTORNEYS AT LAW

TWO NORTH CENTRAL AVENUE

15TH FLOOR

PHOENIX, ARIZONA 85004

April 28, 2016

TELEPHONE (602) 256-0566
FACSIMILE (602) 256-4475

WRITER'S DIRECT LINE
(602) 256-4439
rlane@gblaw.com

VIA ELECTRONIC DELIVERY

Karen Stovall, Senior Planner
Tempe City Hall Municipal Complex
Community Development Department
Lower Level, East Side
31 East Fifth Street
Tempe, AZ 85281
(480) 350-8432
Karen_Stovall@tempe.gov

RE: Eastline Village (Tempe Case No. PL160097)
Public Involvement Final Report

Dear Karen:

This firm represents Eastline Land Ventures L.L.C. (the "Applicant"), a partnership between DMB Associates, Inc. ("DMB"), Apache Partners and Trust No. 95000148. The Applicant is requesting zoning map amendment, planned area development overlay and development plan review approvals (the "Applications") for approximately 13.56 gross acres located at the southwest corner of the intersection of East Apache Boulevard and South River Drive (the "Property"). The purpose of the Applications is to allow for the redevelopment of the Property with a mixed-use urban village (the "Project") which will anchor the east portion of Apache Boulevard and serve as an eastern entry to Tempe.

The purpose of this correspondence is to summarize the project team's discussions with the community in regard to the Project to date. The team has made a concentrated effort to reach out to the community. To date, the team has met with and/or corresponded with representatives of Citizen for a Vibrant Apache Corridor (CVAC) and conducted an official neighborhood meeting. The team has had informal conversations with the Tempe Apache Boulevard Business Association (TABBA) and some representatives of Arizona State University (ASU). The project team will present the Project at the June 1, 2016 TABBA meeting and will have more formal conversations with ASU representatives.

Mailing Notification and Site Posting Dates and Persons and Associations Notified:

On March 28, 2016, the Applicant's legal representative mailed the enclosed notification packet advising of the Project, Applications, and the Project's official neighborhood meeting scheduled for April 19, 2016 to the recipients, including property owners within 600 feet of the

Property, registered associations within one-quarter mile of the Property, and current tenants of the Property. The affidavit of notification and the associated notification map and lists for the notification are enclosed with this report.

On March 31, 2016, Dynamite Signs posted three signs on the Property advising of the Project, the Applications, and the neighborhood meeting scheduled for April 19, 2016. Photographs of the posted sign and the associated affidavit of sign posting are enclosed with this report.

On April 1, 2016, the Applicant's legal representative mailed the enclosed notification packet to all recipients of the March 28th notification to ensure the provision of the aerial photograph of the Property and surrounding area referenced in the first notification. The affidavit of notification and the associated notification map and lists for the notification are enclosed with this report.

Neighborhood Meeting:

On April 19, 2016, we held our official neighborhood meeting for the Project at the Tempe Apache Police Substation located at 1855 East Apache Boulevard. The meeting began at approximately 6:00 p.m. and lasted approximately one hour and 15 minutes. Representatives for the Applicant, Gammage & Burnham, K&I Homes (the Applicant's architect), Espiritu Loci (the Applicant's planning and development consultant) and the Tempe Community Development Department were present. Approximately 18 members of the public also attended the meeting.

The Applicant's legal representative introduced the Applicant and project team and discussed the purpose of the Applications filed with the City. The Applicant's representatives provided an overview of the Applicant's history with the Property and experience in successfully developing mixed-use and master planned developments of a similar scale to the Project, as well as the redevelopment proposal for the Property. The Applicant's architect provided an overview of the general design concept for the Project.

Questions asked by members of the public in attendance at the meeting pertained to 1) the Project's phasing plan; 2) the Project's target demographic and inclusion of "family friendly" amenities and features; 3) the proposed number of residential units; 4) if the Project would include any for-sale units; 5) the design and intended use of the Project's plaza; 6) if the development proposal included property owned by the City of Tempe; and, 7) proposed building materials. All questions raised by members of the public in attendance at the meeting were addressed by the project team. General community interest in regard to the Project needing to be incorporated into the surrounding community have been addressed through the openness (i.e. not walled off) of the Project's site design and the provision of an amenity plaza capable of hosting community/neighborhood events. General comments regarding the Project needing to be family friendly have been addressed through the provision a varied unit mix, high-quality interior features and top-tier amenities.

Contact information for persons in attendance at the meeting is provided on the enclosed sign-in sheet. One comment sheet expressing support for the Project was completed and submitted by a member of the public attending the meeting. The submitted comment sheet is enclosed.

Meeting with CVAC

On March 16, 2016, the development team met with CVAC. The project team described the project, talked about the transition of Apache Boulevard, the elements necessary to create a village in the community and how this development will be open to the surrounding properties. CVAC members in attendance appeared to be generally supportive of the project.

Summary of E-Mail and Phone Correspondence with Neighbors and Interested Parties:

To date, the Applicant's legal representative has received three phone calls from neighbors in regard to the Project.

The purpose of the first two calls was to advise that the aerial photograph of the Property referenced in our March 28, 2016 notification letter advising of the Project, Applications, and the Project's official neighborhood meeting had not been included in our notification packet. In response, the Applicant's legal representative mailed the noted aerial photograph of the Property to all recipients of the March 28th notification packet on April 1st. On March 31st, the Applicant's legal representative also e-mailed an electronic copy of the noted aerial photograph to Matt Nelson of the Escalante Neighborhood Association. Copies of the noted notification and e-mail correspondence are enclosed with this report.

On April 25th, the Applicant's legal representative received a phone call from Mike Williams. The purpose of Mr. Williams call was to advise that he had recently spotted migratory American Kestrel falcons on the Property and to learn about the Project's development timeline. The Applicant's legal representative advised Mr. Williams that the Project was in the early stages of the entitlement and development plan review process and that construction activity on the Property was not imminent. Based on the information provided by the Applicant's legal representative, Mr. Williams indicated that the falcons' current breeding season would not be disturbed.

On April 26th, the Applicant's legal representative received a phone call from Bob Stafford, area property owner, requesting the provision of a copy of the mailing notification packet for the Project's official neighborhood meeting held on April 19th. The Applicant's legal representative mailed the requested packet to Mr. Stafford on April 26th.

To date, the Applicant's legal representative has received one e-mail expressing opposition to the Project. The received e-mail is enclosed with this summary.

Total Number of Persons Notified and/or Participating:

As reflected by the enclosed notification lists and sign-in sheets from the neighborhood meeting conducted on April 19th, as well as the summary of e-mail and phone correspondence to date provided above, approximately 154 persons have been notified of the Project and Applications and/or participated in the public review process to date.

Continued Outreach:

The Applicant and the Applicant's legal representative intend to continue to meet with community members who express an interest in the Project. In the event that any additional correspondence or meetings occur, an update to this report will be provided as we get closer to public hearings.

Please let us know if you require any additional information in regard to the summary of meetings and public outreach provided above.

Sincerely,
GAMMAGE & BURNHAM P.L.C.



By

Rob Lane
Land Use Planner

Enclosures

Robert Lane

From: Annelie Muller <[REDACTED]>
Sent: Saturday, April 23, 2016 3:57 PM
To: Robert Lane
Subject: Re: Case# PL160097

Follow Up Flag: Follow Up
Due By: Saturday, April 23, 2016 4:43 PM
Flag Status: Flagged

On Apr 23, 2016 3:52 PM, "Annelie Muller" <[REDACTED]> wrote:

I hereby opose your plan to build any 4story buildings on Apache Blvd.between Smith and River Ave.also Condos. Plus sofar the Buildings you have builded the Colors you have done are a complete Eyesore.Also your lawyer did not send to all the residences on my street or any other street letters with your attention on your plans.this highly Hispanic neighborhood.I am a senior and eventually I will be moving to a 55and up apartment complex.The rent you are charging for a 1bedroom is outragues.I could not afort this amount. Anyways I'm against your proposal.Also in case noone had informed in the apartments on River Ave.there are living alot of Sexafenders. Sincerely Annelie Muller [REDACTED]

Jarrad, Cynthia

From: Jarrad, Cynthia
Sent: Wednesday, August 17, 2016 8:11 AM
To: Jarrad, Cynthia
Subject: FW: Eastline Project - August 23 Agenda.

----- Original message -----

From: Matt Nelson <
Date: 8/16/16 12:50 PM (GMT-07:00)
To: "Adame, Sarah" <Sarah_Adame@tempe.gov>
Cc: mvaz@gblaw.com
Subject: Eastline Project - August 23 Agenda.

To: Tempe Development Review Commission

I will be working during your meeting hours but I would like to comment on one of your agenda items.

We feel the Eastline Project will be a great improvement to our neighborhood. The south side of Apache in this area is the source of much crime and the area full of empty lots and abandoned buildings. This project should be a great improvement.

This area needs decent high quality housing. These type of residential projects should lead to greater commercial and retail options which are lacking along Apache Ave.

We hope you approve this project.

Thank you.

Matt Nelson

President, Escalante Neighborhood Association

Matthew Salenger, AIA; co-chair for Citizens for a Vibrant Apache Corridor (CVAC)



August 21, 2016

City Council & Design Review Commission
City of Tempe

To Whom It May Concern,

When we founded CVAC in 2014, one of our initial and most important goals was to improve the devastatingly disturbing conditions along the east portion of Apache Boulevard. The area has for years been lined with derelict buildings, burned out structures, failing businesses, and daily visible crime.

For years we have been advocating for the city to remove the worst vacant structures that serve to increase crime and decrease the area's development viability. While the City continues to seek legal methods to assist our area with this need, we have been looking forward to the Jeff Jones/DMB Eastline Project in order to finally make some progress on improving the eastern side of the corridor. We see this project as a crucial step in forming all of Apache Corridor into what was envisioned when the light rail arrived nearly ten years ago.

In this letter, I will attempt to portray why CVAC feels it is critical for the Design Review Commission (DRC) and City Council to approve this project.

1. Working with the community. As you may know, our group includes all the neighborhood association chairs along the corridor. We attempt to speak for the neighborhoods and advocate for the most appropriate development in our area. We were approached by Jeff Jones over two years ago to discuss this project, and have been working with him and (later) DMB to ensure this project is a big gain for our area. We supported Jeff's initial vision and we also fully support the current proposal because it is well designed and appropriate for our area.
2. Providing for the community. Not only does the project include a massive property clean-up and investment in our area, it does so with some of the most thoughtful and impressive planning we have seen to date. Taking on the very best of current urban planning (particularly those put forward in Jeff Speck's book, Walkable City), this development allows for a maximum of mobility, porosity, and urbanity with just the right level of density. By including an area for public gatherings and "hang-outs" within a plaza, it provides a space that (thus far) no other developer has given us along

Apache, and is something we really need. Beyond all the great planning and taking our area into consideration, it is the simple act of investing that is the most valuable of all. We are doubly pleased they are planning it correctly.

3. Providing economic viability. This particular stretch of Apache could have easily been first developed by a company that provides rental units at the lowest quality, which would have made it difficult to improve the area upward and bring much-needed business. Instead, Jones/DMB are taking the risk and aiming high. By supplying high-quality market-rate housing along Apache along with the gathering plaza at the center of the development, this eastern side of Apache has something to build on for the future. Their planning also provides the very best chance for economic success to actually bring retail to the area. Unlike most of other previous developments along Apache, our understanding is DMB provides funds in their pro forma to assist businesses in moving into their development.
4. Creating a successful model. Jones/DMB truly seems to understand the need to attract people from outside the development to this location to make it successful for the tenants and the community. They are supplying the plaza, but also the street access and free parking as part of the initial development to make the site work. Only by making it easy for outsiders to be a part of the site will it allow businesses to flourish. And by doing so, they also attract the next phase of tenants. This maximizes true success for the development and our area.
5. Providing for-ownership housing. One of CVAC's main concerns is increasing owner-occupied housing in our area. This is the first development to provide any ownership opportunities during our tenure. And their idea of providing it through work-live units is an innovative and intriguing one. Here again, it is our understanding they are planning on providing funds for the commercial build-out for the owners that purchase these units. As a part-time developer myself, I understand the incredibly difficult task to make ownership financially feasible for large developments in our current economic environment. This is a bold step towards finding a viable model for areas such as ours.

For all these reasons and more, we ask that the DRC and City Council approve the Eastline Project without delay. We view the construction of this development as a tremendously important game-changing moment for the Apache Corridor.

Sincerely yours, Matthew Salenger, AIA